
DRAWING INDEX

SDP 1.1	SITE PLAN
SDP 1.2	SITE DETAILS
SDP 1.3	SITE DETAILS
SDP 2.1	LANDSCAPE PLAN
CG-101	GRADING AND DRAINAGE PLAN
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SDP 5.1	EXTERIOR BUILDING ELEVATIONS
SDP 5.2	EXTERIOR BUILDING ELEVATIONS
SDP 6.1	SITE LIGHTING FOR REFERENCE
SDP 6.2	ELECTRICAL SITE PLAN FOR REFERENCE
FIRE-1	FIRE HYDRANT LOCATION AND ACCESS PLAN

VICINITY MAP

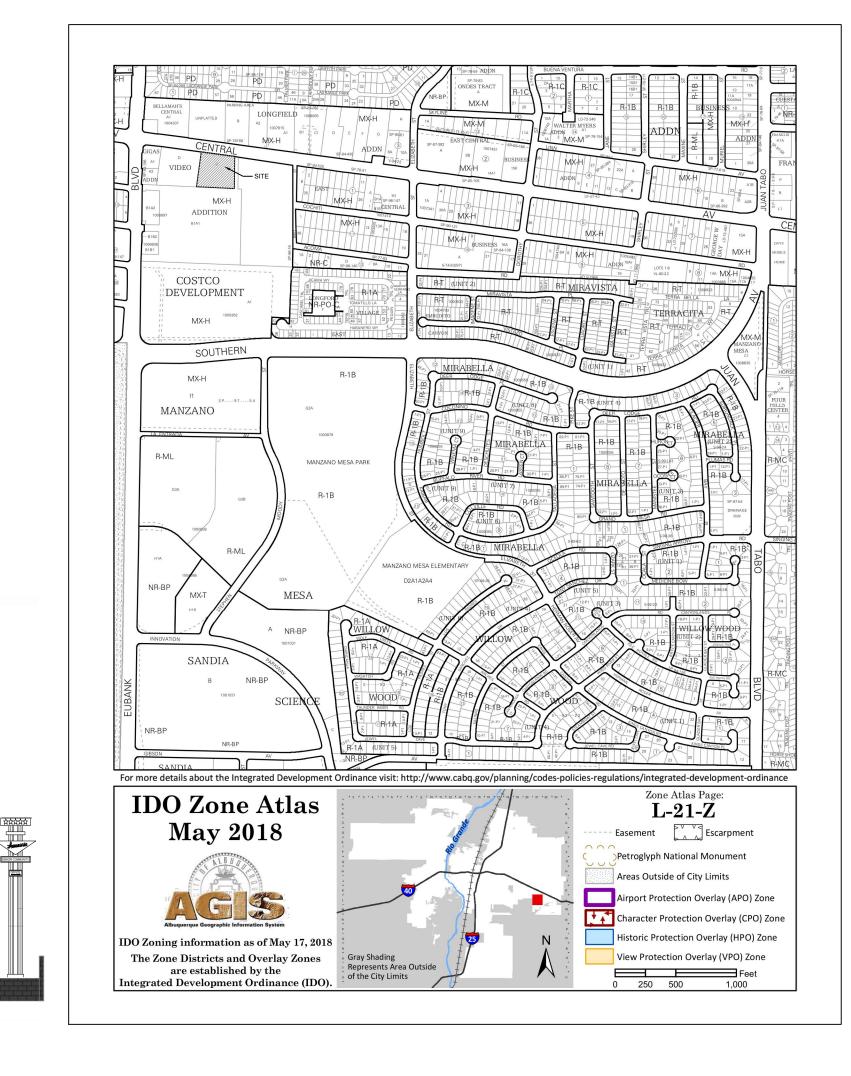

LUMINARIA SENIOR COMMUNITY

OWNER

LUMINARIA APARTMENTS LIMITED PARTNERSHIP, LLLP 320 GOLD AVENUE SW #918 ALBUQUERQUE, NM 87102 PHONE: 505.244.1614

ARCHITECT

DEKKER/PERICH/SABATINI, LTD. 7601 JEFFERSON ST. NE, SUITE 100 ALBUQUERQUE, NM 87109 PHONE: 505.761.9700

LANDSCAPE ARCHITECT


DEKKER/PERICH/SABATINI, LTD. 7601 JEFFERSON ST. NE, SUITE 100 ALBUQUERQUE, NM 87109 PHONE: 505.761.9700

CIVIL ENGINEER

ISAACSON & ARFMAN, INC. 128 MONROE STREET NE ALBUQUERQUE, NM 87108 505.268.8828

DEKKER PERICH SABATINI

ARCHITECTURE DESIGN INSPIRATION

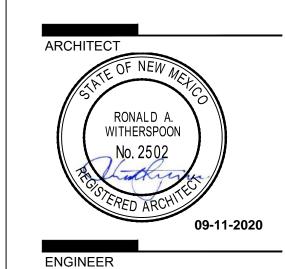

PRO IECT

-UMINARIA SENIOR COMMUNIT 10600 CENTRAL AVE SE ALBUQUERQUE, NM 87123


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DRAWN BY	AG, JF
REVIEWED BY	RAW, HFG
DATE	09/11/2020
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DRAWING NAME	

SDP FOR BUILDING PERMIT

SHEET NO.

COVER

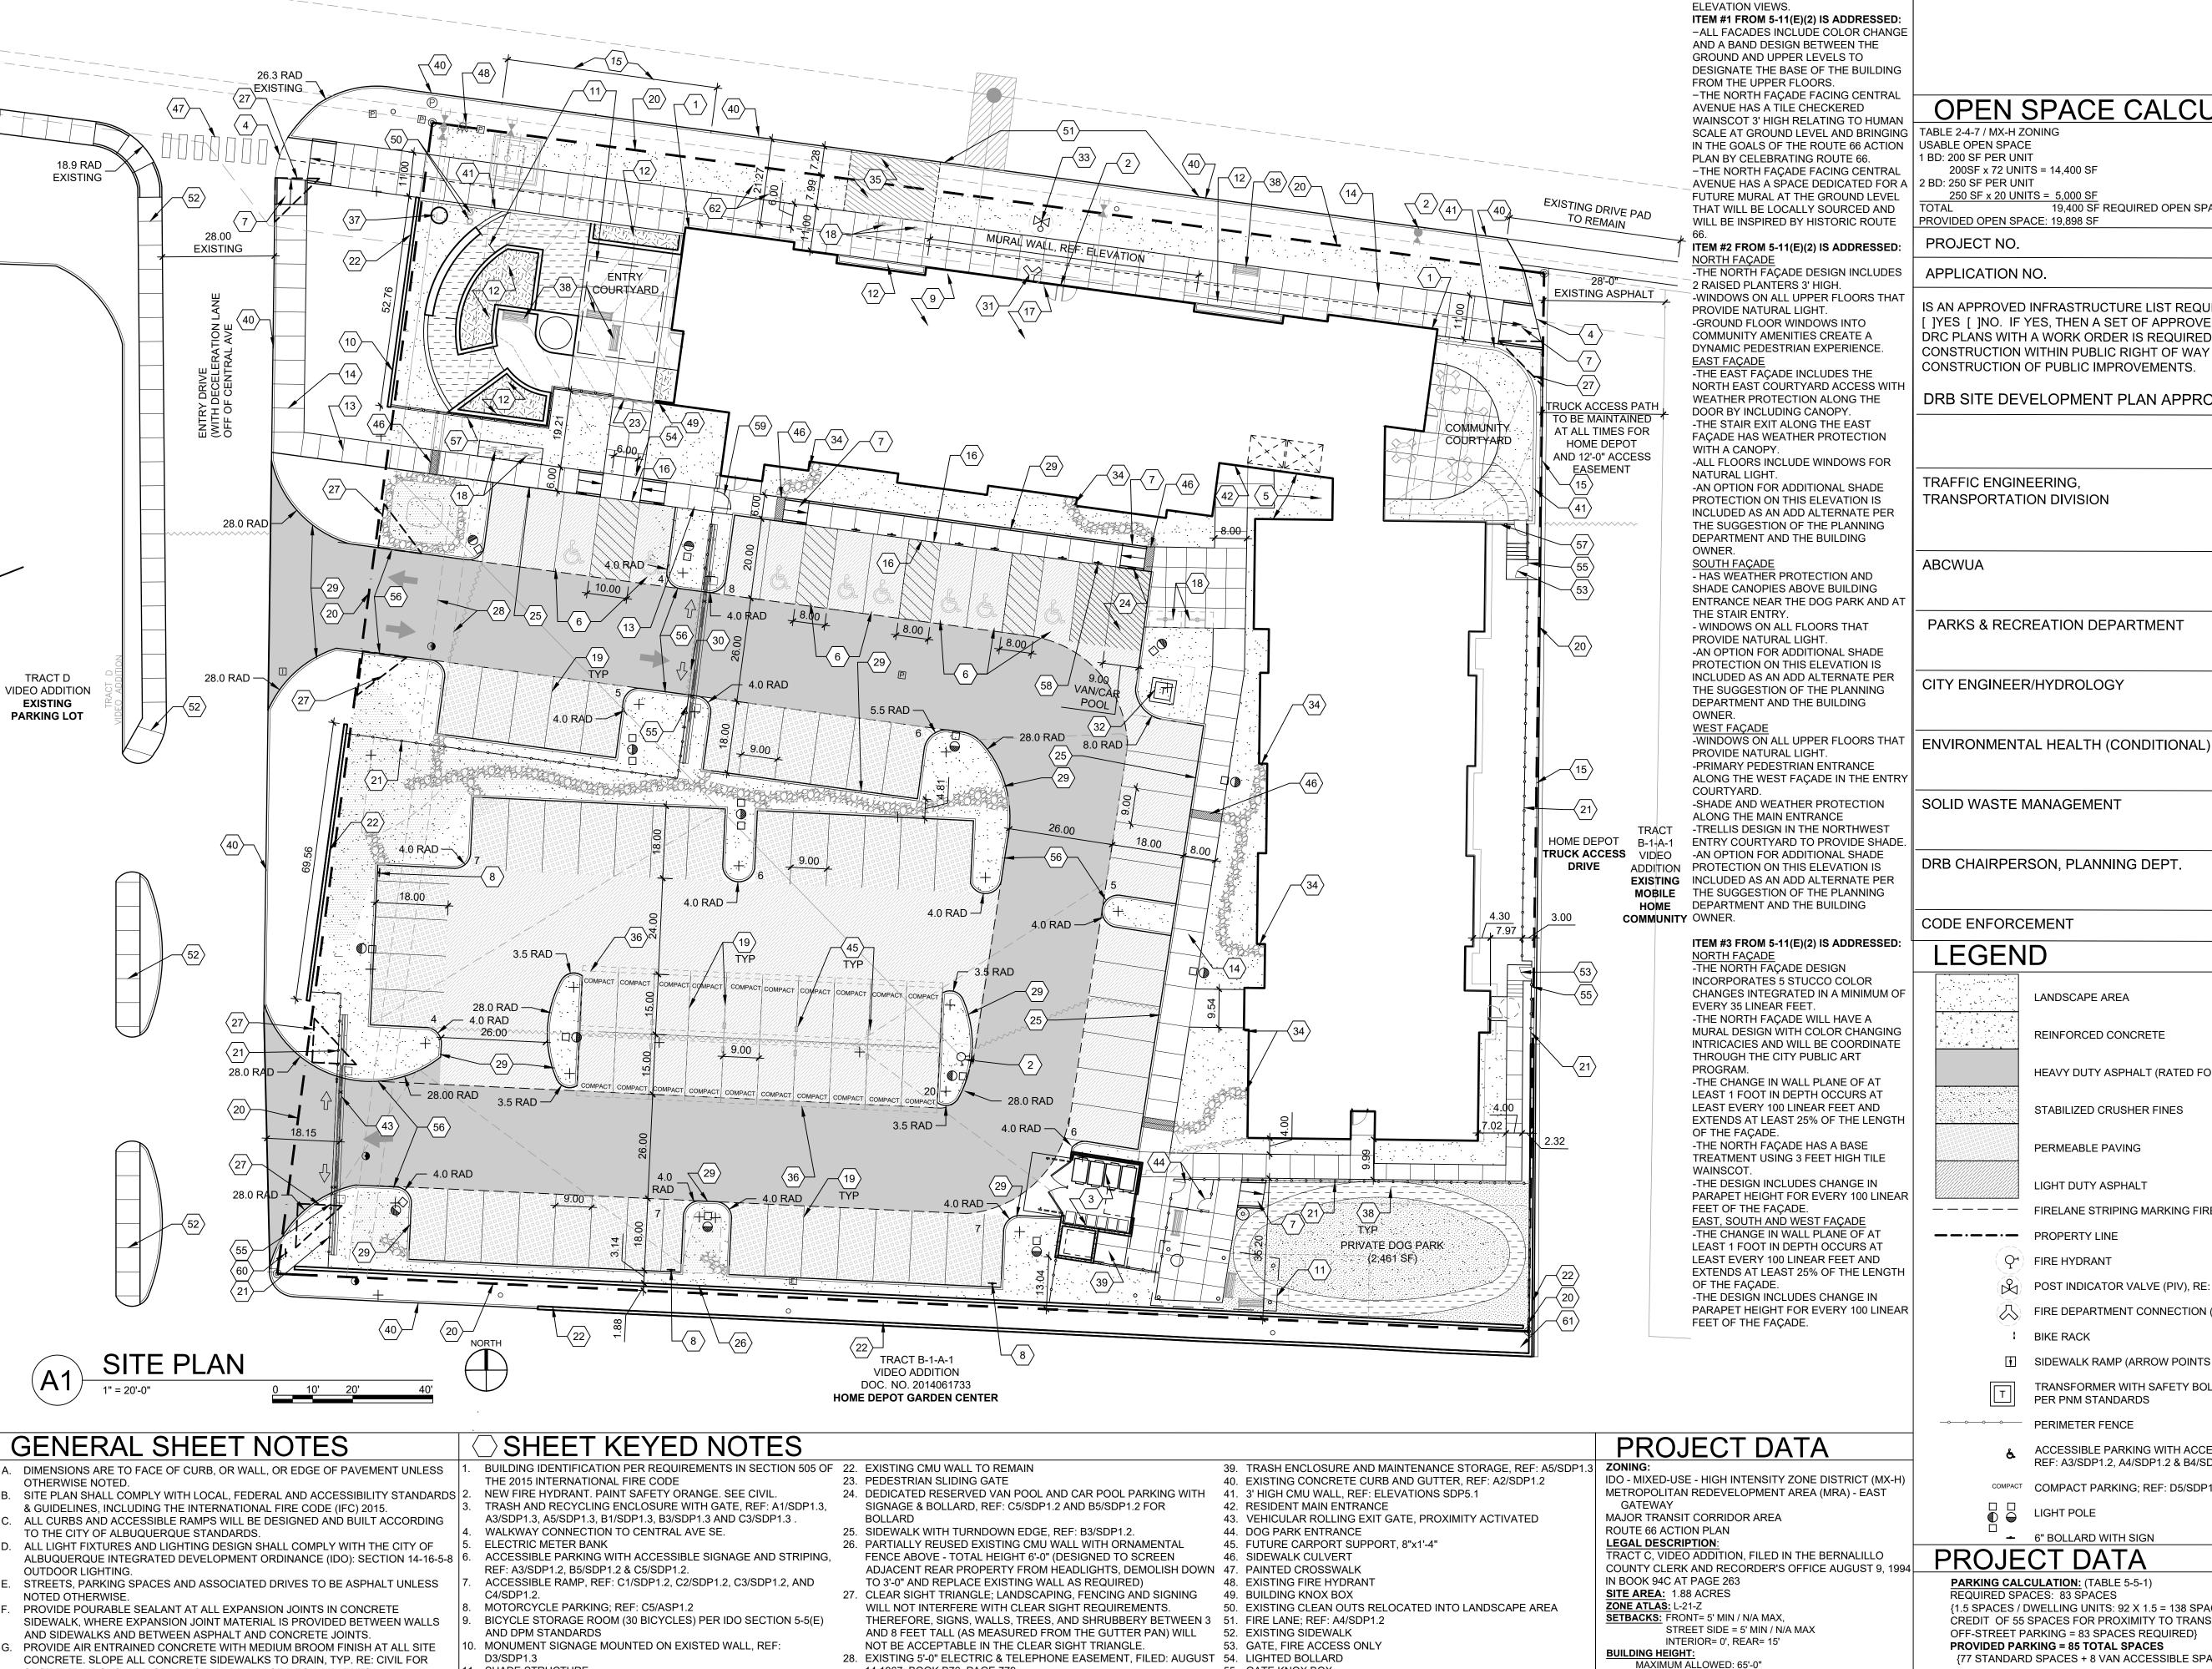

14,1967, BOOK B76, PAGE 779

33. POST INDICATOR VALVE (PIV)

PROVIDED)

REQUIRED

38. BENCH

29. CONCRETE HEADER CURB; REF B1/SDP1.2

30. VEHICULAR ROLLING ENTRY GATE, FOB ACTIVATED

32. ELECTRICAL TRANSFORMER (ON 6" CONCRETE PAD)

34. DOWNSPOUT TO COBBLE RUN OFF, RE: CIVIL PLANS

31. FIRE DEPARTMENT CONNECTION (FDC) WALL-MOUNTED

35. OPTION FOR FUTURE CITY BUS SHELTER (CONCRETE PAD

37. VERTICAL MARQUEE SIGN, REF: C2/SDP1.3 AND B1/SDP1.3

36. OPTION FOR PHOTOVOLTAIC (PV) CAR PORT, SEPARATE PERMIT

55. GATE KNOX BOX

& LEGEND

D2/SDP1.3

56. FIRELANE STRIPING MARKING FIRE ACCESS LANE; REF: A4/SDP1.2

57. 3' HIGH CMU WALL WITH 3' HIGH ORNAMENTAL FENCE ABOVE; REI

62. SIDEWALK ACCESS EASEMENT TO BE DEDICATED TO THE CITY OF

ALBUQUERQUE TO INCLUDE 6'-0" OF SIDEWALK MINIMUM TO BACK

58. DEDICATED RESERVED LOADING/UNLOADING PARKING WITH

SIGNAGE & BOLLARD, REF: C5/SDP1.2

60. DO NOT ENTER SIGNAGE; REF: C5/ASP1.2

59. PEDESTRIAN GATE; REF: D5/SDP1.2

61. SIGHT MIRROR, POST-MOUNTED

OF CURB ON CENTRAL

SHADE STRUCTURE

13. 6' WIDE CONCRETE SIDEWALK PER COA IDO STANDARDS, REF:

18. OUTDOOR BIKE RACK/PARKING PER IDO AND DPM STANDARD WITH

16. FLUSH CONCRETE SIDEWALK, REF: B3/SDP1.2

TWO-POINT BIKE LOCKING, REF: C1/SDP1.3

21. ORNAMENTAL FENCE, REF: D4/SDP1.2

12. PLANTER

REQUIREMENTS. THEREFORE SIGNS, WALLS AND PLANTING BETWEEN 3 FEET AND 14. 8' WIDE SIDEWALK CONCRETE, REF: B4/SDP1.2.

AN ACCESSIBLE ROUTE, IN COMPLIANCE WITH ACCESSIBILITY STANDARDS OF THE 19. PARKING STRIPING 4" WIDE, COLOR WHITE

PROJECT, CONNECTS FROM THE BUILDING TO ACCESSIBLE PARKING SPACES AND 20. PROPERTY LINE

8 FEET TALL (AS MEASURED FROM THE GUTTER PAN) WILL NOT BE PERMITTED IN 15. NEW CONCRETE CURB AND GUTTER, REF: A2/SDP1.2

B4/SDP1.2.

17. FIRE RISER ROOM

SPOT ELEVATIONS, AND GRADING AND DRAINAGE REQUIREMENTS.

SOLID WASTE CONNECTION IS THE RESPONSIBILITY OF THE CITY OF

LANDSCAPE AND SIGNAGE WILL NOT INTERFERE WITH CLEAR SIGHT

ALL EXISTING ASPHALT AND CONCRETE TO BE REMOVED PRIOR TO

ALBUQUERQUE SOLID WASTE DEPARTMENT.

THE CLEAR SIGHT TRIANGLE.

TO ALL SITE AMENITIES AS REQUIRED

CONSTRUCTION

K. REMOVE EXISTING TREES

OPEN SPACE CALCULATIONS

USABLE OPEN SPACE 1 BD: 200 SF PER UNIT

200SF x 72 UNITS = 14,400 SF

19,400 SF REQUIRED OPEN SPACE

PROJECT NO.

APPLICATION NO.

REFER TO SDP5.1 AND SDP5.2 FOR

IS AN APPROVED INFRASTRUCTURE LIST REQUIRED? []YES []NO. IF YES, THEN A SET OF APPROVED DRC PLANS WITH A WORK ORDER IS REQUIRED FOR ANY CONSTRUCTION WITHIN PUBLIC RIGHT OF WAY OR FOR CONSTRUCTION OF PUBLIC IMPROVEMENTS.

DRB SITE DEVELOPMENT PLAN APPROVAL:

TRAFFIC ENGINEERING, TRANSPORTATION DIVISION

DATE:

DATE:

DATE:

DATE:

DATE:

DATE:

DATE:

DATE:

LEGEND LANDSCAPE AREA REINFORCED CONCRETE HEAVY DUTY ASPHALT (RATED FOR UP TO 75,000 LBS) STABILIZED CRUSHER FINES

PERMEABLE PAVING LIGHT DUTY ASPHALT

———— FIRELANE STRIPING MARKING FIRE ACCESS LANE; REF: A4/SDP1.2

→ FIRE HYDRANT

POST INDICATOR VALVE (PIV), RE: CONCEPTUAL UTILITY PLAN FIRE DEPARTMENT CONNECTION (FDC) WALL-MOUNTED

BIKE RACK

SIDEWALK RAMP (ARROW POINTS DOWN)

TRANSFORMER WITH SAFETY BOLLARDS & 6" THICK CONCRETE PAD PER PNM STANDARDS

PERIMETER FENCE ACCESSIBLE PARKING WITH ACCESSIBLE SIGNAGE AND STRIPING,

REF: A3/SDP1.2, A4/SDP1.2 & B4/SDP1.2. COMPACT PARKING; REF: D5/SDP1.3

LIGHT POLE

← 6" BOLLARD WITH SIGN

REQUIRED SPACES: 83 SPACES {1.5 SPACES / DWELLING UNITS: 92 X 1.5 = 138 SPACES MINUS PARKING CREDIT OF 55 SPACES FOR PROXIMITY TO TRANSIT, VANPOOL PARKING, AND OFF-STREET PARKING = 83 SPACES REQUIRED}

= 3 SPACES

= 3 SPACES

PROVIDED PARKING = 85 TOTAL SPACES {77 STANDARD SPACES + 8 VAN ACCESSIBLE SPACES}

MOTORCYCLE PARKING REQUIRED MOTORCYCLE PARKING PROVIDED

ACTUAL HEIGHT: 51'-9"

SPRINKLED: YES, NFPA 13R

BUILDING OCCUPANCY: R-2

CONSTRUCTION TYPE: TYPE VA

17,505 GSF

17,095 GSF

17,095 GSF

17,095 GSF 68,793 GSF

FIRE FLOW: 2,375 GPM

HYDRANTS REQUIRED: 2

BUILDING SF:

SECOND LEVEL

THIRD LEVEL

FOURTH LEVEL

FIRST LEVEL

BICYCLE PARKING REQUIRED = 23 SPACES (0.25 SPACES PER DU = 92 X 0.25 = 23 SPACES) **BICYCLE PARKING PROVIDED** = 42 SPACES

(30 INDOOR BICYCLE SPACES + 12 OUTDOOR BICYCLE SPACES)

12 OUTDOOR SPACES ARE PROVIDED FOR VISITORS THAT ARE FIXED. PERMANENT AND ARE LOCATED AT MULTIPLE RACKS SERVING THE LEASING OFFICE, AND ALONG CENTRAL AVENUE PER THE ROUTE 66 **ACTION PLAN**

DEKKER PERICH SABATINI

ARCHITECTURE DESIGN **INSPIRATION**




PROJECT

APPLICATION TO DESIGN REVIEW BOARD (DRB)

REVISIONS


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SITE PLAN

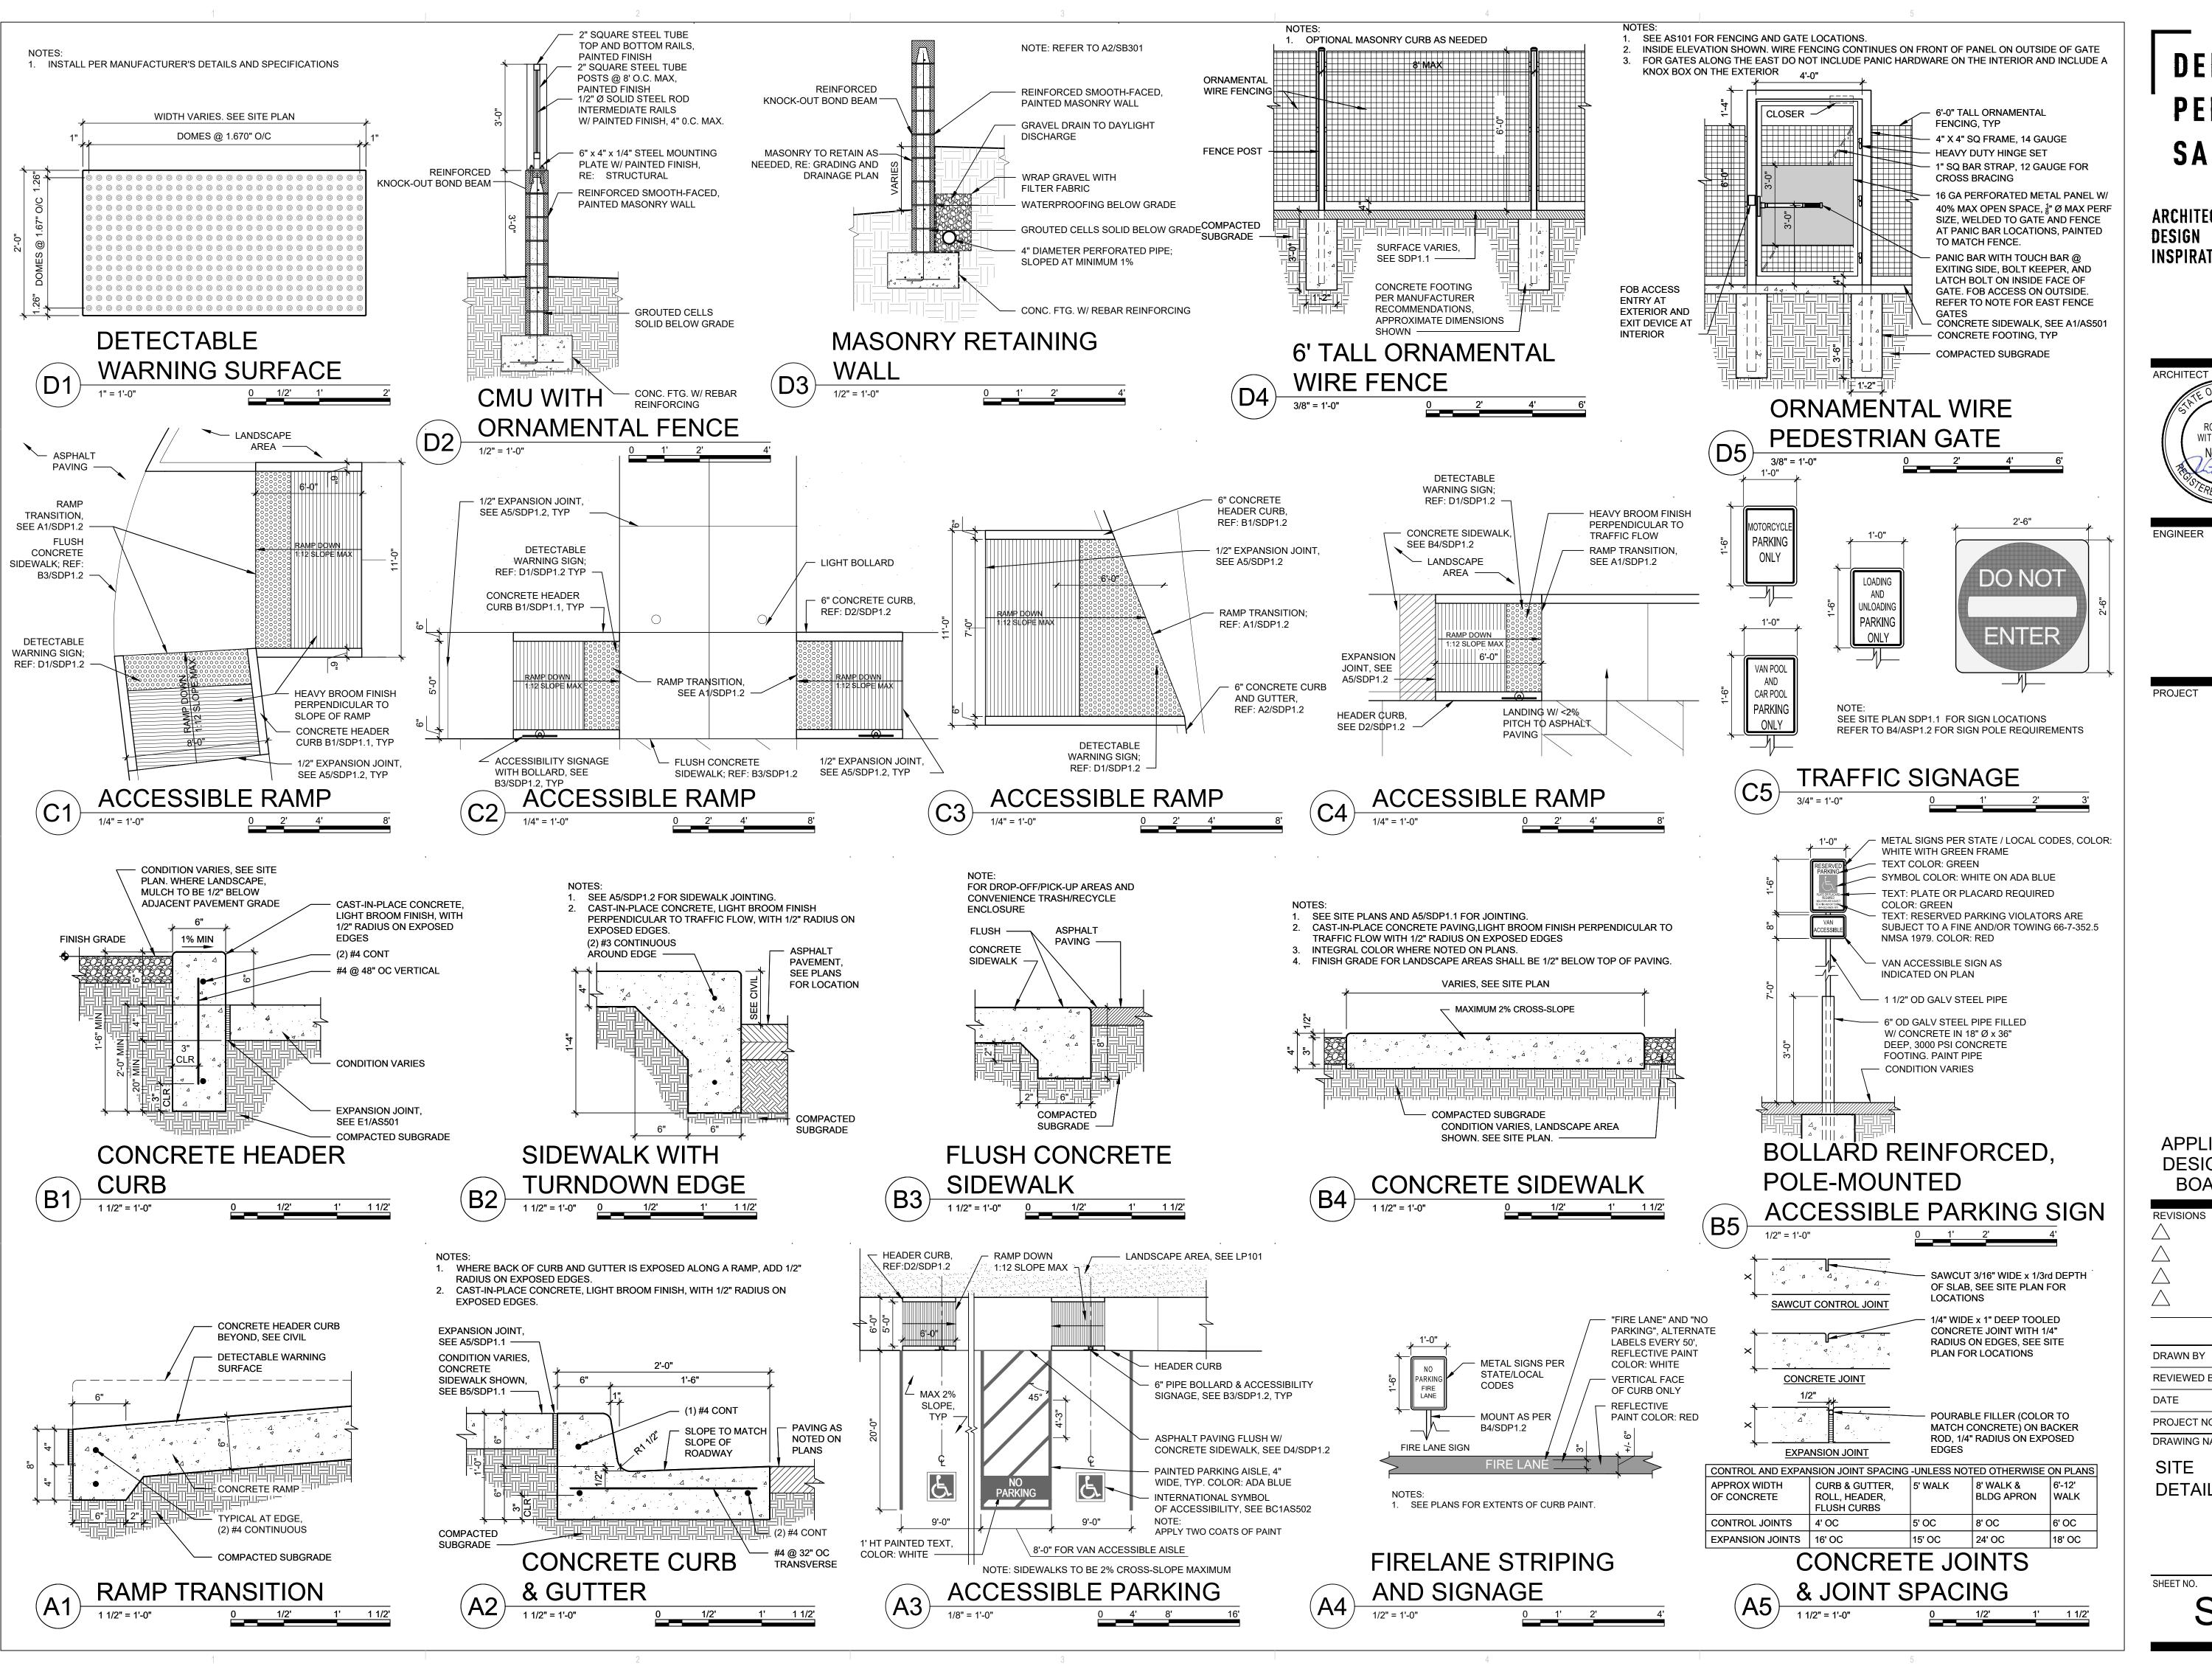

PERICH SABATINI

ARCHITECTURE DESIGN **INSPIRATION**

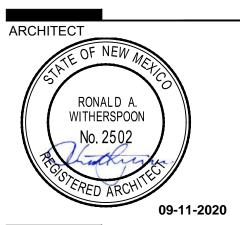

PROJECT


ARIA SENIOR 10600 CENTRAL AY ALBUQUERQUE, NIV

APPLICATION TO DESIGN REVIEW BOARD (DRB)

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SITE **DETAILS**

SHEET NO. **SDP1.2**

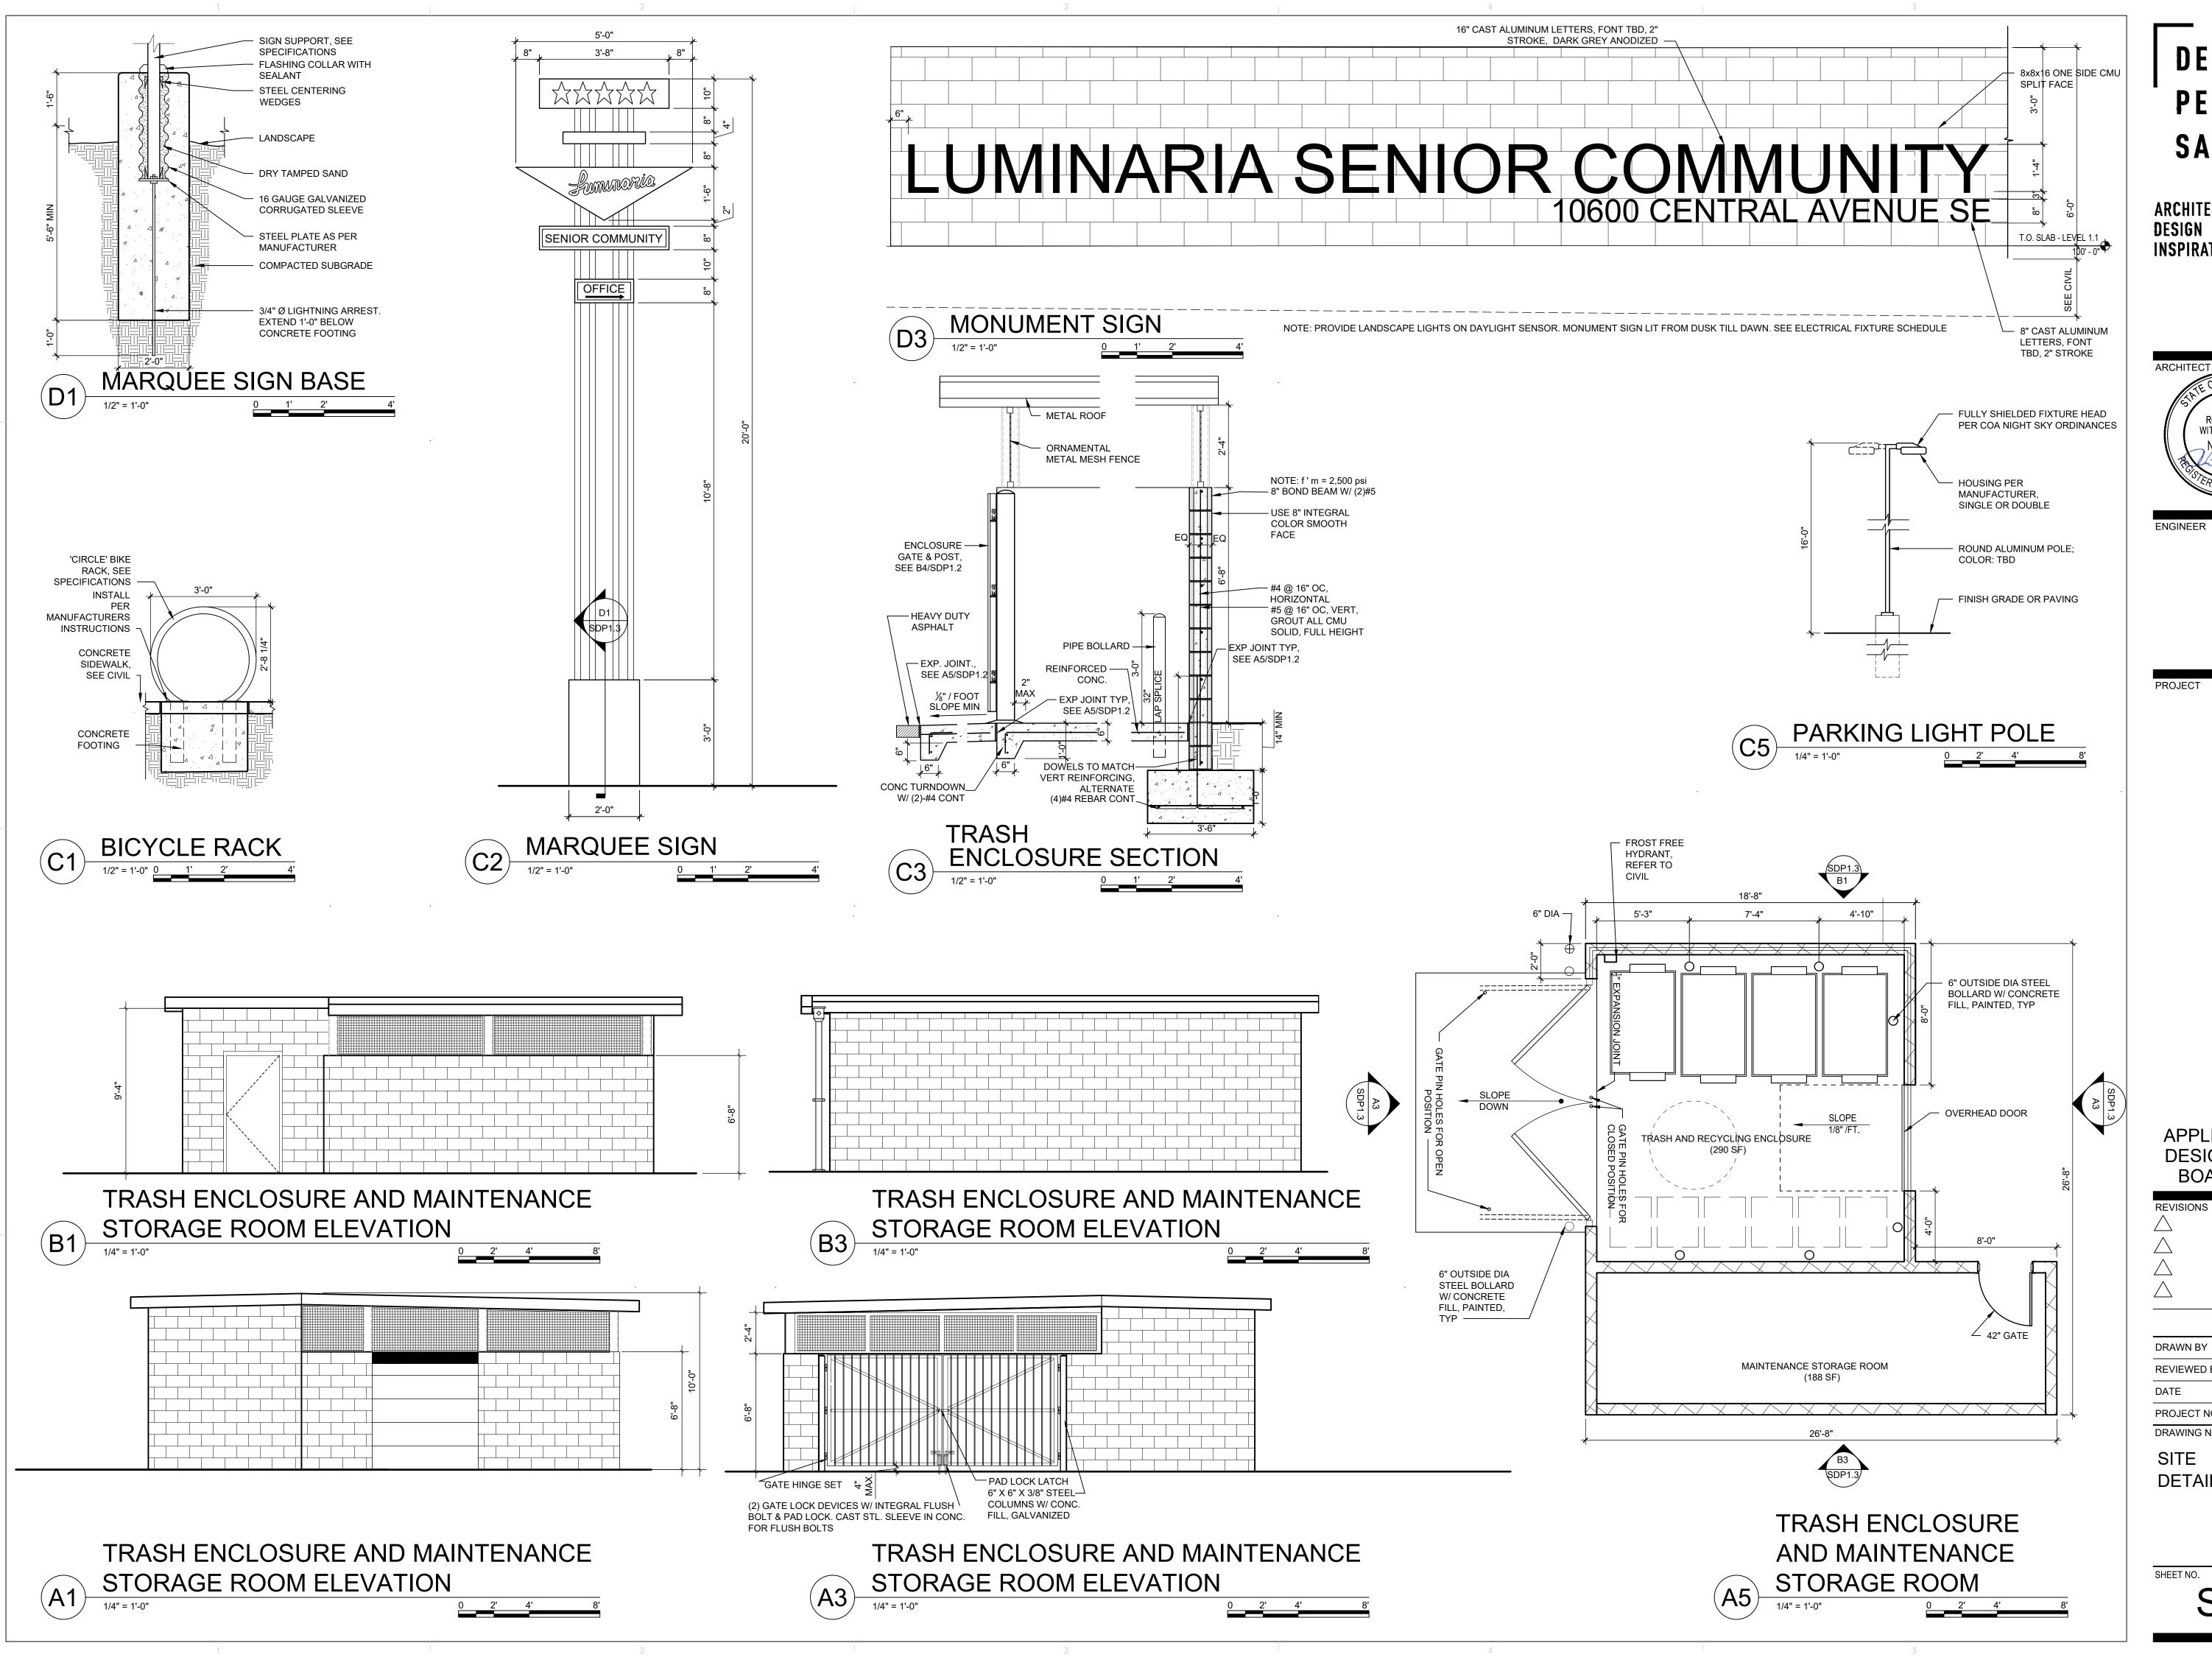

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ARCHITECTURE DESIGN **INSPIRATION**



PROJECT


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BOARD (DRB) REVISIONS

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SITE **DETAILS**

SDP1.3



PLANT SCHEDULE

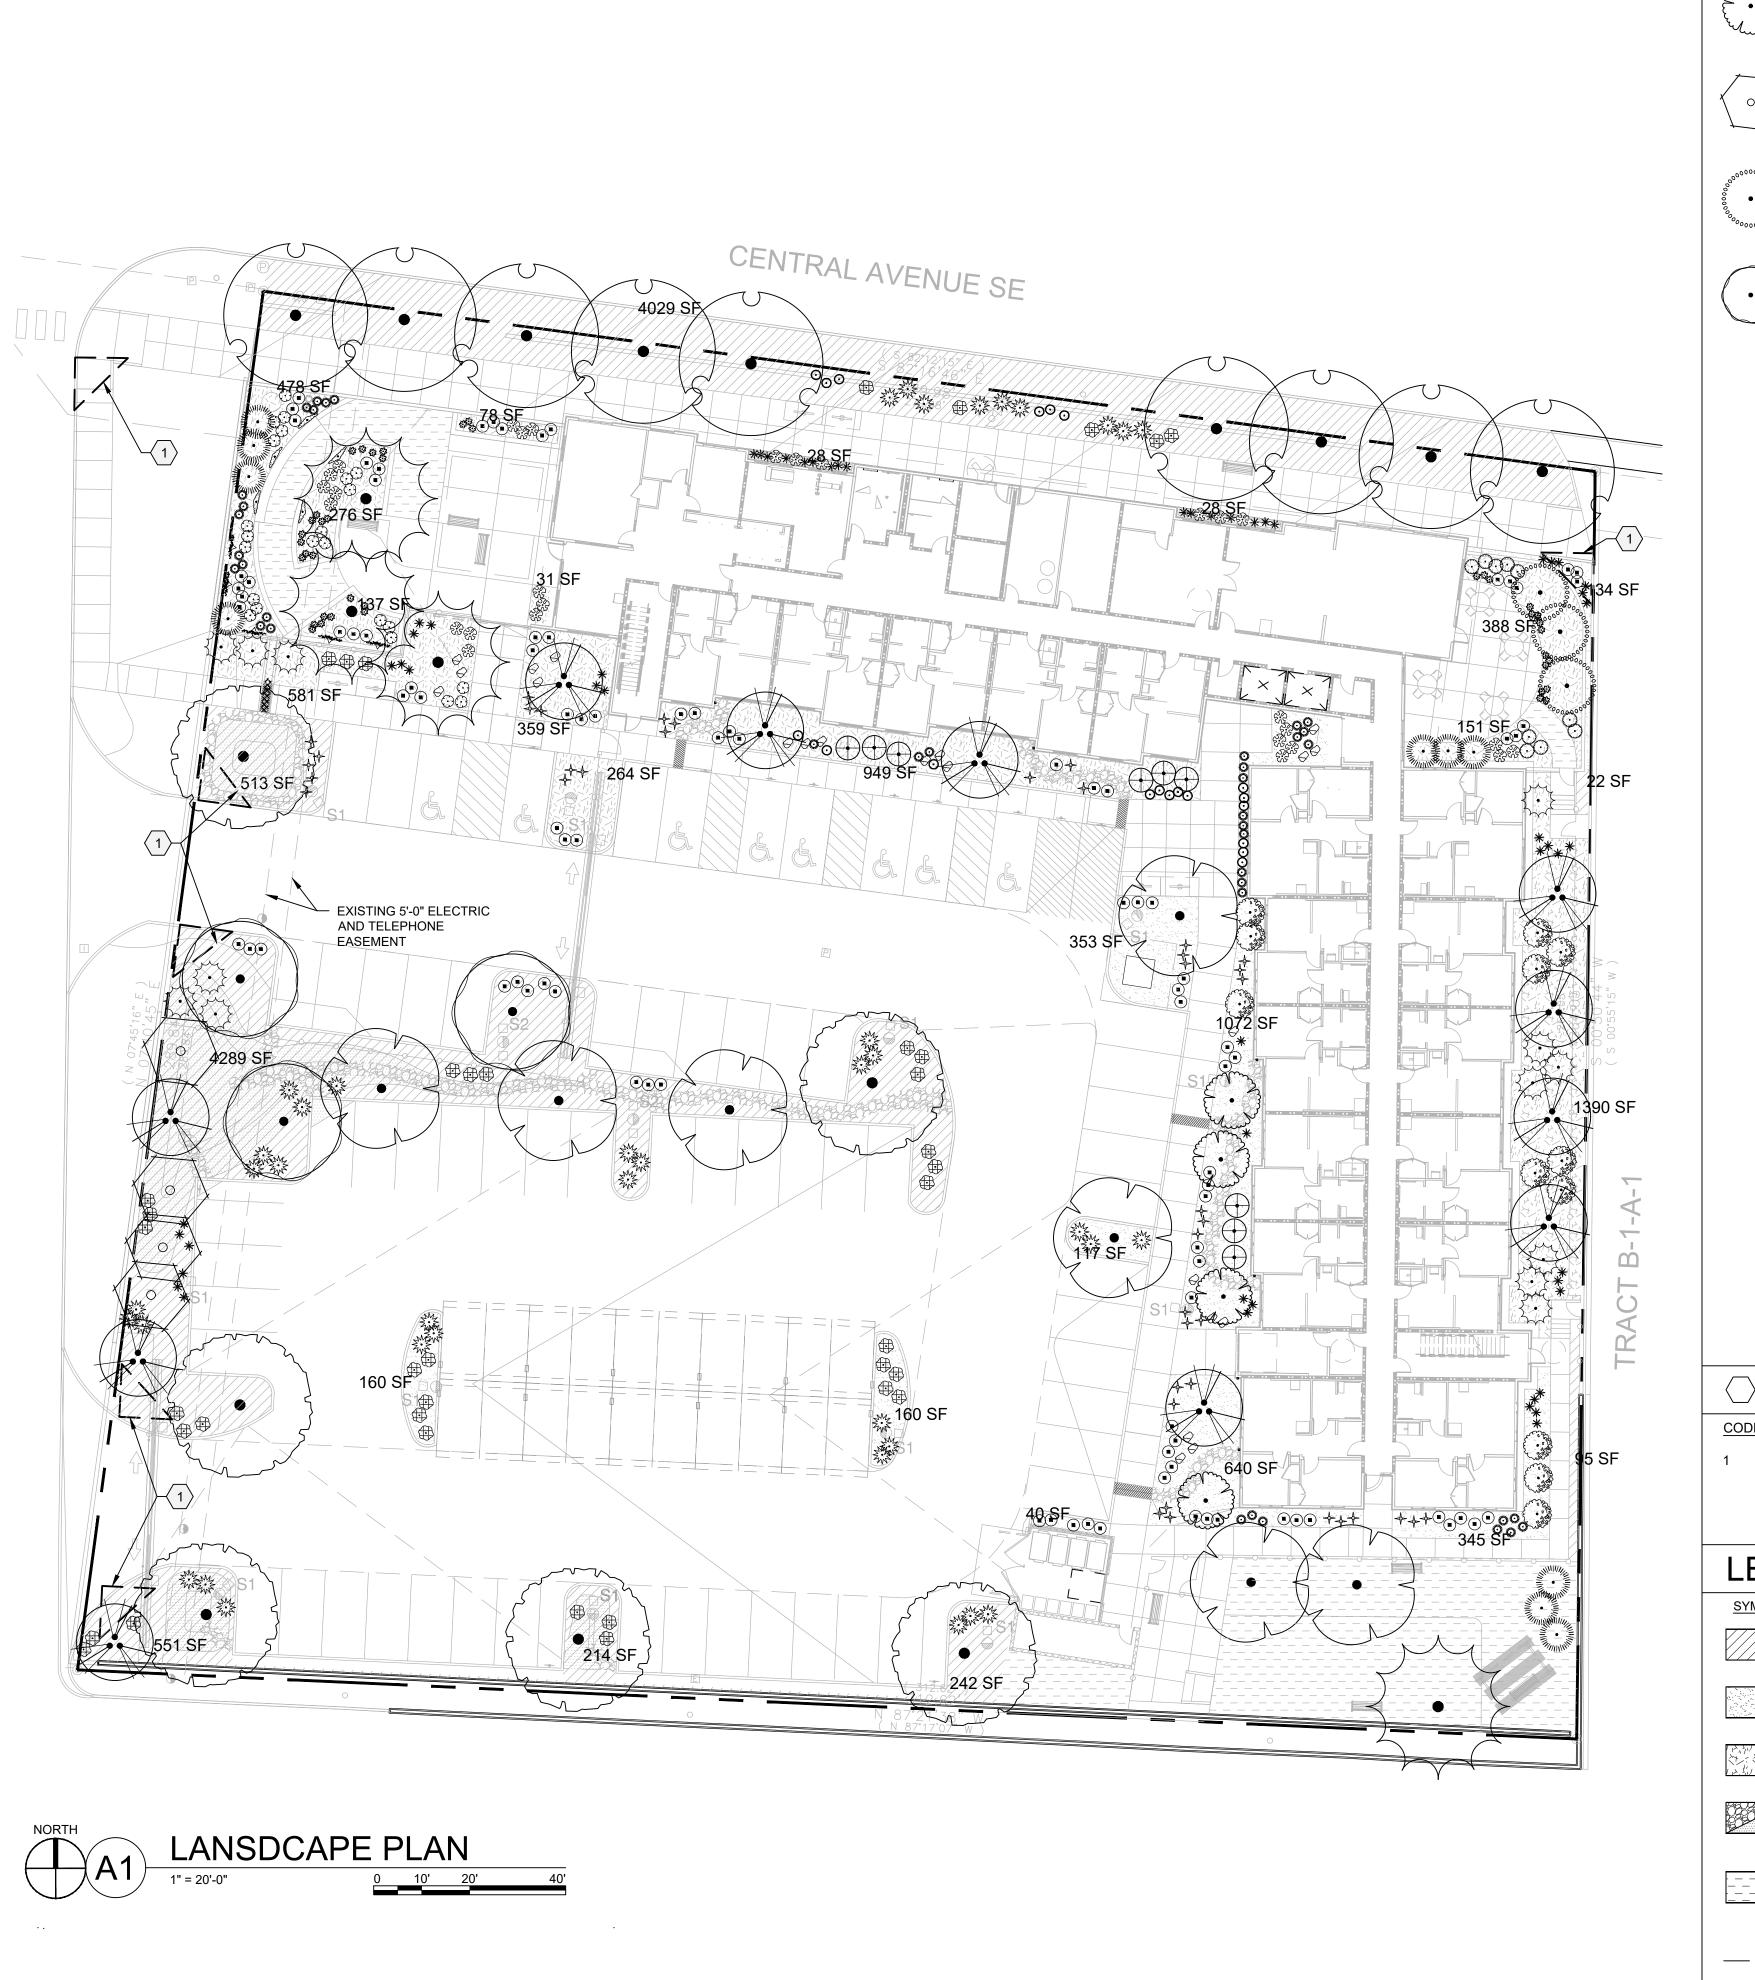COMMON NAME AUTUMN BLAZE MAPLE OKLAHOMA RED BUD **'BUBBA' DESERT WILLOW** NEW MEXICO OLIVE

CHINESE PISTACHE

CRESTHAVEN PEACH

LITTLE LEAF MOUNTAIN MAHOGANY

BUCKLEY OAK

CHINKAPIN OAK

ACCOLADE ELM

SHRUBS COMMON NAME

LENA BROOM

 \bigoplus

DESERT MAHONIA

CREEPING MAHONIA

KNOCKOUT ROSE

LITTLELEAF MOCKORANGE

GOLDEN BAMBOO

DESERT ACCENTS **COMMON NAME** BRAKELIGHTS RED YUCCA

TWISTLEAF YUCCA

ORNAMENTAL GRASSES COMMON NAME

'BLONDE AMBITION' BLUE GRAMA

DEER GRASS

PERENNIALS COMMON NAME CHOCOLATE FLOWER

KIT CAT CATMINT

ULTRA VIOLET AUTUMN SAGE

SISKIYOU PINK GAURA

COMMON NAME TANGERINE BEAUTY CROSS VINE

HIMROD GRAPE

SHEET KEYED NOTES

DESCRIPTION

CLEAR SIGHT TRIANGLE; LANDSCAPING, FENCING AND SIGNING WILL NOT INTERFERE WITH CLEAR SIGHT REQUIREMENTS. THEREFORE, SIGNS, WALLS, TREES, AND SHRUBBERY BETWEEN 3 AND 8 FEET TALL (AS MEASURED FROM THE GUTTER PAN) WILL NOT BE ACCEPTABLE IN THE CLEAR SIGHT TRIANGLE.

5,140 SF

LEGEND

<u>NOTES</u> <u>SYMBOL</u>

EST QTY 3/4"Ø ROCK MULCH AT 3" DEPTH 9,955 SF OVER WEED BARRIER FABRIC

CRUSHER FINES AT 3" DEPTH OVER 3,020 SF WEED BARRIER FABRIC



SEE CIVIL FOR STORMWATER

INFRASTRUCTURE



STABILIZED CRUSHER FINES EXCLUDED FROM LANDSCAPE AREA CALCULATIONS, SEE SITE

— — — PROPERTY LINE

GENERAL SHEET NOTES

A. RESPONSIBILITY FOR MAINTENANCE: THE CONTRACTOR WILL BE RESPONSIBLE FOR MAINTENANCE OF THE LANDSCAPE DURING CONSTRUCTION AND DURING A 90 DAY-MAINTENANCE PERIOD FOLLOWING SUBSTANTIAL COMPLETION. THE OWNER WILL BE RESPONSIBLE FOR MAINTENANCE FOLLOWING THE 90-DAY MAINTENANCE PERIOD.

B. STATEMENT OF COMPLIANCE WITH CITY OF ALBUQUERQUE: THE LANDSCAPE DESIGN WILL COMPLY WITH THE CITY OF ALBUQUERQUE'S LANDSCAPING,

BUFFERING, AND SCREENING REGULATIONS (14-16-5-6), WATER CONSERVATION ORDINANCE AND POLLEN ORDINANCE. C. TIMING OF LANDSCAPE INSTALLATION: INSTALLATION OF THE LANDSCAPING

SHALL BE COMPLETE WITHIN 60 DAYS OF THE RELATED BUILDING'S OCCUPANCY. D. SURFACE TREATMENT: ALL LANDSCAPE AREAS SHALL BE COVERED WITH VEGETATION AND/OR MULCH. ORGANIC MULCH IS REQUIRED AT EACH TREE ROOTBALL AREA/DRIPLINE.

E. LANDSCAPE AND SIGNAGE WILL NOT INTERFERE WITH CLEAR SIGHT REQUIREMENTS. THEREFORE SIGNS, WALLS, TREES AND SHRUBS BETWEEN 3 AND 8 FEET TALL (AS MEASURED FROM THE GUTTER PAN) WILL NOT BE PERMITTED IN THE CLEAR SIGHT TRIANGLE.

F. MINIMUM PLANT SIZES ARE AS PER CITY OF ALBUQUERQUE STANDARDS PER TABLE 5-6-1 OF THE IDO.

G. AREAS DISTURBED DURING CONSTRUCTION, INCLUDING AREAS NOT WITHIN THE PROPERTY LINE, WILL BE STABILIZED. H. VEGETATIVE SCREENING SURROUNDING GROUND-MOUNTED TRANSFORMERS AND UTILITY PADS SHALL ALLOW 10' OF CLEARANCE MINIMUM IN FRONT OF THE EQUIPMENT DOOR AND 5' OF CLEARANCE MINIMUM ON THE REMAINING SIDES

FOR SAFE OPERATION AND MAINTENANCE. NO EXISTING PLANT MATERIAL IS TO BE PRESERVED ON THE PROPERTY. ALL PLANT MATERIALS ILLUSTRATED ARE NEW.

IRRIGATION NOTES

- A. PLANTS SHALL BE IRRIGATED BY AN AUTOMATED IRRIGATION SYSTEM, WITH PROGRAMMABLE SETTINGS, AUTOMATED IRRIGATION CONTROLLER, AND MOISTURE SENSOR TO AVOID OVERWATERING.
- B. THE IRRIGATION SYSTEM SHALL BE DESIGNED TO MINIMIZE THE USE OF WATER. C. THE IRRIGATION SYSTEM SHALL NOT IRRIGATE IMPERVIOUS SURFACES,
- INCLUDING SIDEWALKS, DRIVEWAYS, STREETS, PARKING, AND LOADING AREAS. D. IRRIGATION POINT OF CONNECTION TO THE CITY WATER WILL BE LOCATED WITHIN PROPERTY LIMITS AND SHALL COMPLY WITH THE CITY OF ALBUQUERQUE REDUCED PRESSURE BACKFLOW PREVENTER STANDARDS AND SPECIFICATIONS.
- E. RUN TIMES AND IRRIGATION ZONES SHALL BE BASED UPON PLANT SPECIES AND THEIR ESTABLISHMENT. RUN TIMES SHALL BE REGULARLY ADJUSTED BY THE OWNER ACCORDING TO PLANT MATURITY, SEASON, LOCATION AND PERFORMANCE. F. IRRIGATION TO BE DESIGN-BUILD BY THE CONTRACTOR

LANDSCAPE CALCULATIONS

TOTAL SITE AREA = 1.88 AC = 81,829 SF AREA OF LOT COVERED BY BUILDINGS = 17,505 SF NET LOT AREA= 64,324 SF

REQUIRED LANDSCAPE

REQUIRED LANDSCAPE AREA (15% OF NET LOT AREA) = 9,649 SF PROVIDED LANDSCAPE AREA = 18,114 SF = 28% (see hatch legend for exclusions from landscape areas)

TREES PER PARKING SPACES: REQUIRED= 1 TREE / 10 PARKING SPACES TOTAL NUMBER OF PARKING = 85 SPACES REQUIRED NUMBER OF PARKING LOT TREES = 9 TREES PROVIDED NUMBER OF PARKING LOT TREES = 12 TREES

NO PARKING SPACE MAY BE MORE THAN 100 FEET AWAY FROM A TREE TRUNK

REQUIRED STREET TREES = 9 placed at 30' on center (276' of street frontage) PROVIDED STREET TREES = 9

REQUIRED TREES FOR MULTI-FAMILY RESIDENTIAL DEVELOPMENTS = 42 TREES 1 TREE PER GROUND FLOOR DWELLING UNIT (17) AND 1 TREE PER SECOND-STORY PROVIDED TREES FOR MULTI-FAMILY RESIDENTIAL DEVELOPMENTS = 50 TREES

REQUIRED VEGETATIVE COVERAGE
REQUIRED GROUND COVERAGE = 13,585 SF = 75% OF PROVIDED LANDSCAPE AREA A MINIMUM 25% OF REQUIRED VEGETATIVE COVERAGE BY GROUND PLANTS PROVIDED TOTAL GROUND COVERAGE = 5,962 SF = 32% OF TOTAL PROVIDED LS

GROUND PLANT COVERAGE = 5,962 SF = 43% OF REQUIRED VEGETATIVE COVERAGE

PARKING LOT AREA = 38,112 SF PARKING LOT LANDSCAPING PROVIDED = 6,082 SF = 15% MIN. 15% OF PARKING LOT AREA TO BE LANDSCAPED

TREE CANOPY COVERAGE = 18,434 SF


TOTAL ROCK MULCH GROUND COVER = 12,976 SF = 71% TOTAL ORGANIC MULCH GROUND COVER = 5,138 SF = 28% A MAXIMUM OF 75% OF GRAVEL OR CRUSHER FINES IS PERMITTED 14-16-5-6(C)(5)(d)

PARKING LOT EDGE LANDSCAPE
2 TREES AND 6 SHRUBS PER 25' ARE PROVIDED ALONG THE WEST PROPERTY LINE TO SCREEN PARKING.

TREE PLANTING DETAIL

3 TIMES ROOTBALL DIAMETER

1. PRIOR TO BACKFILLING, MATERIAL SUCH AS CONTAINERS, WIRE, BURLAP AND ROPE SHALL BE COMPLETELY REMOVED. 2. PLANT MATERIAL SHALL BE PLANTED IN UNCOMPACTED SOIL.

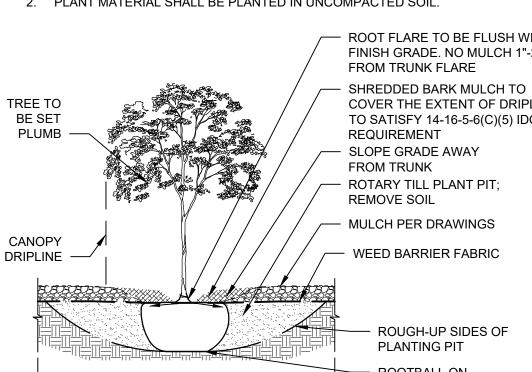

ROOT FLARE TO BE FLUSH WITH FINISH GRADE. NO MULCH 1"-2" COVER THE EXTENT OF DRIPLINE TO SATISFY 14-16-5-6(C)(5) IDO


ROOTBALL ON UNDISTURBED SOIL

SDP2.1

LANDSCAPE PLAN

DEKKER PERICH SABATINI

ARCHITECTURE DESIGN **INSPIRATION**

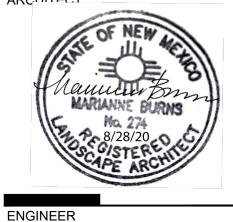

PROJECT

ARIA SENIOR C 10600 CENTRAL AVI ALBUQUERQUE, NM 8

APPLICATION TO DESIGN REVIEW

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D/P/S

19-0058

08/28/2020

BOARD (DRB) REVISIONS


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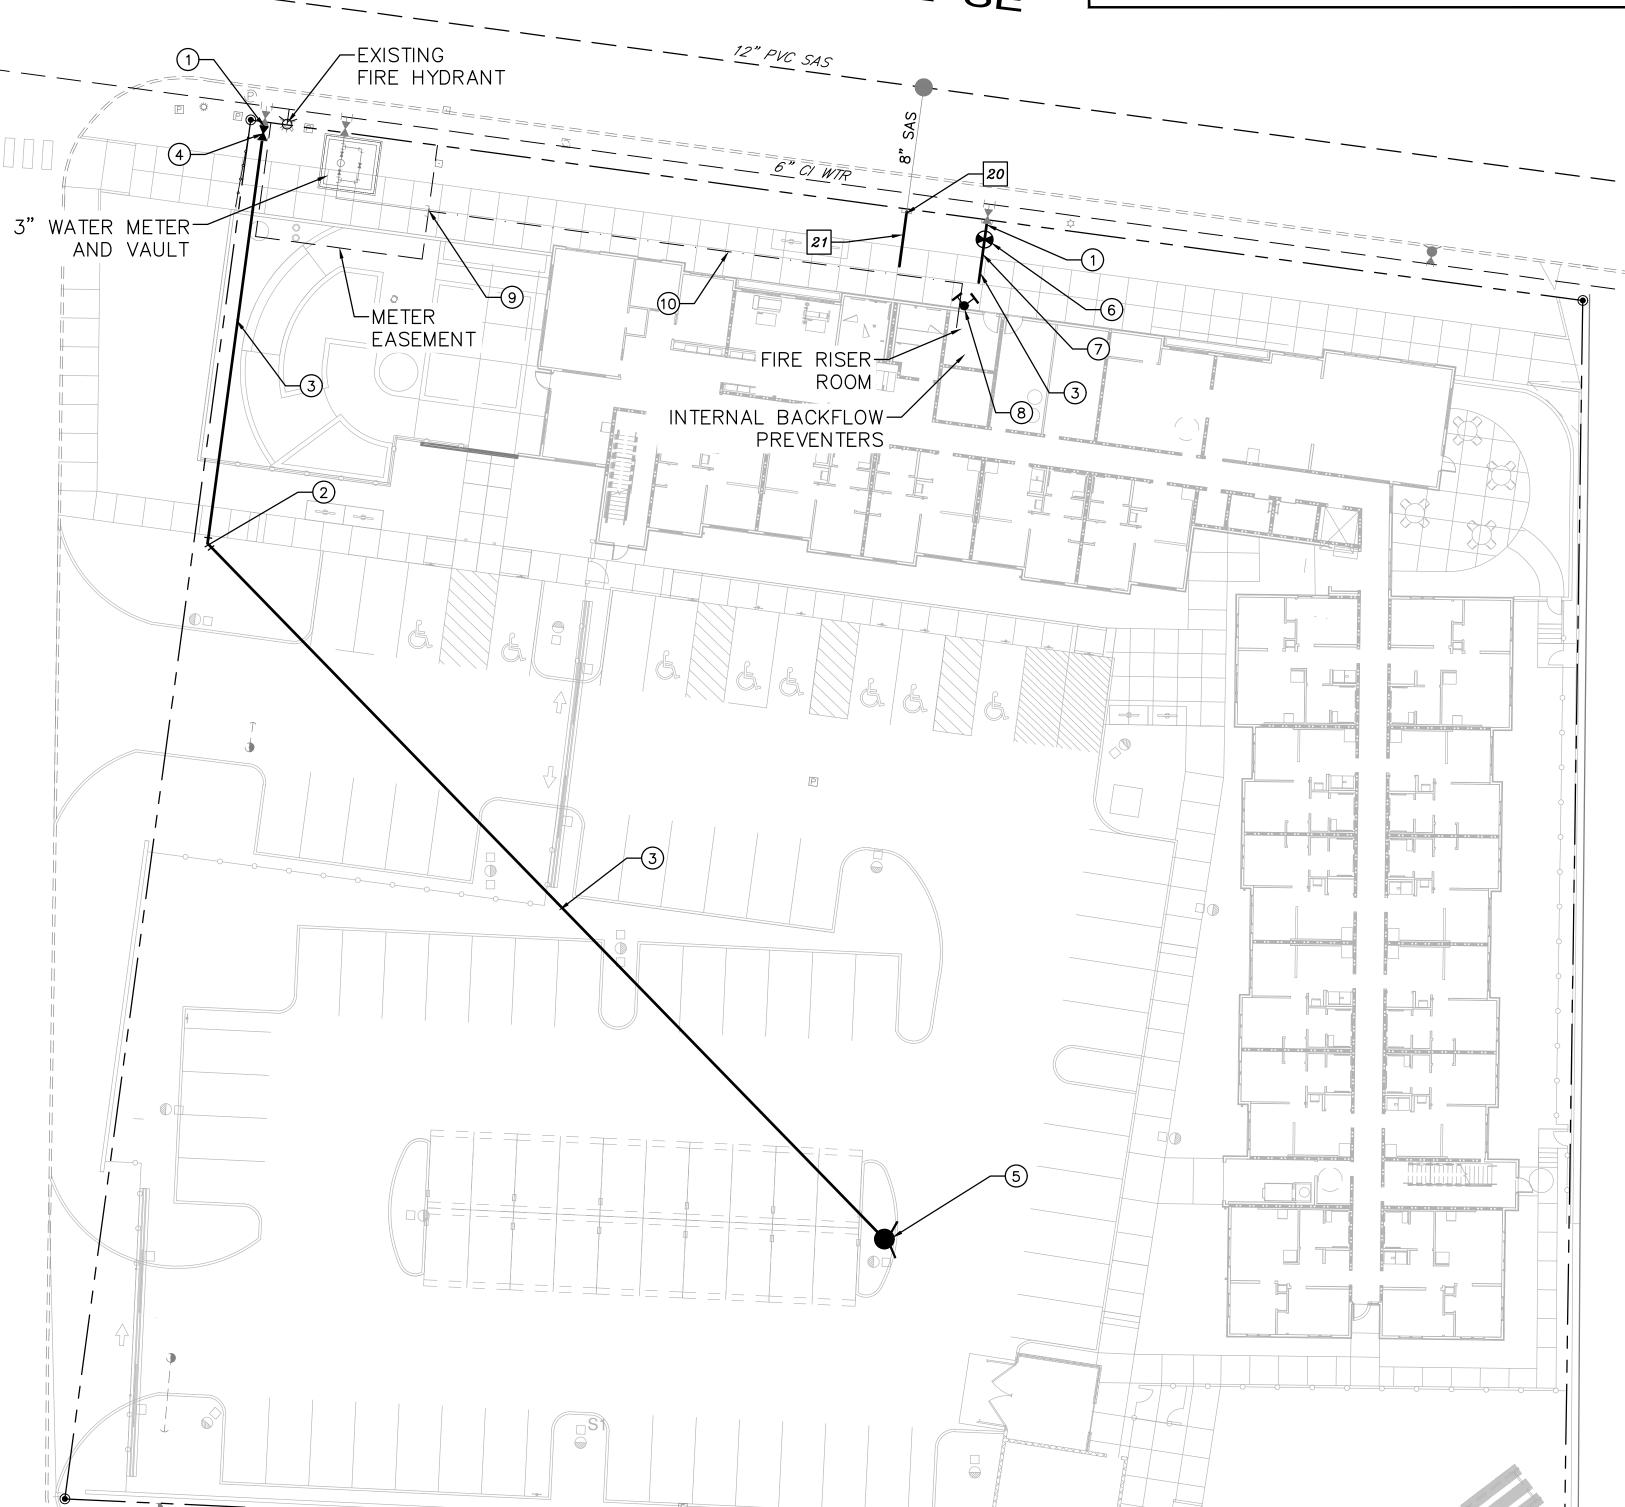
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DRAWING NAME



CENTRAL AVE SE

PRIVATE FIRE LINES, FIRE HYDRANT AND 3" METER WITH VAULT CONNECTIONS TO PUBLIC WATERLINE AND SEWER MANHOLE ON EXISTING SEWER MAIN TO BE CONSTRUCTED UNDER COA/ABCWUA WORK ORDER.

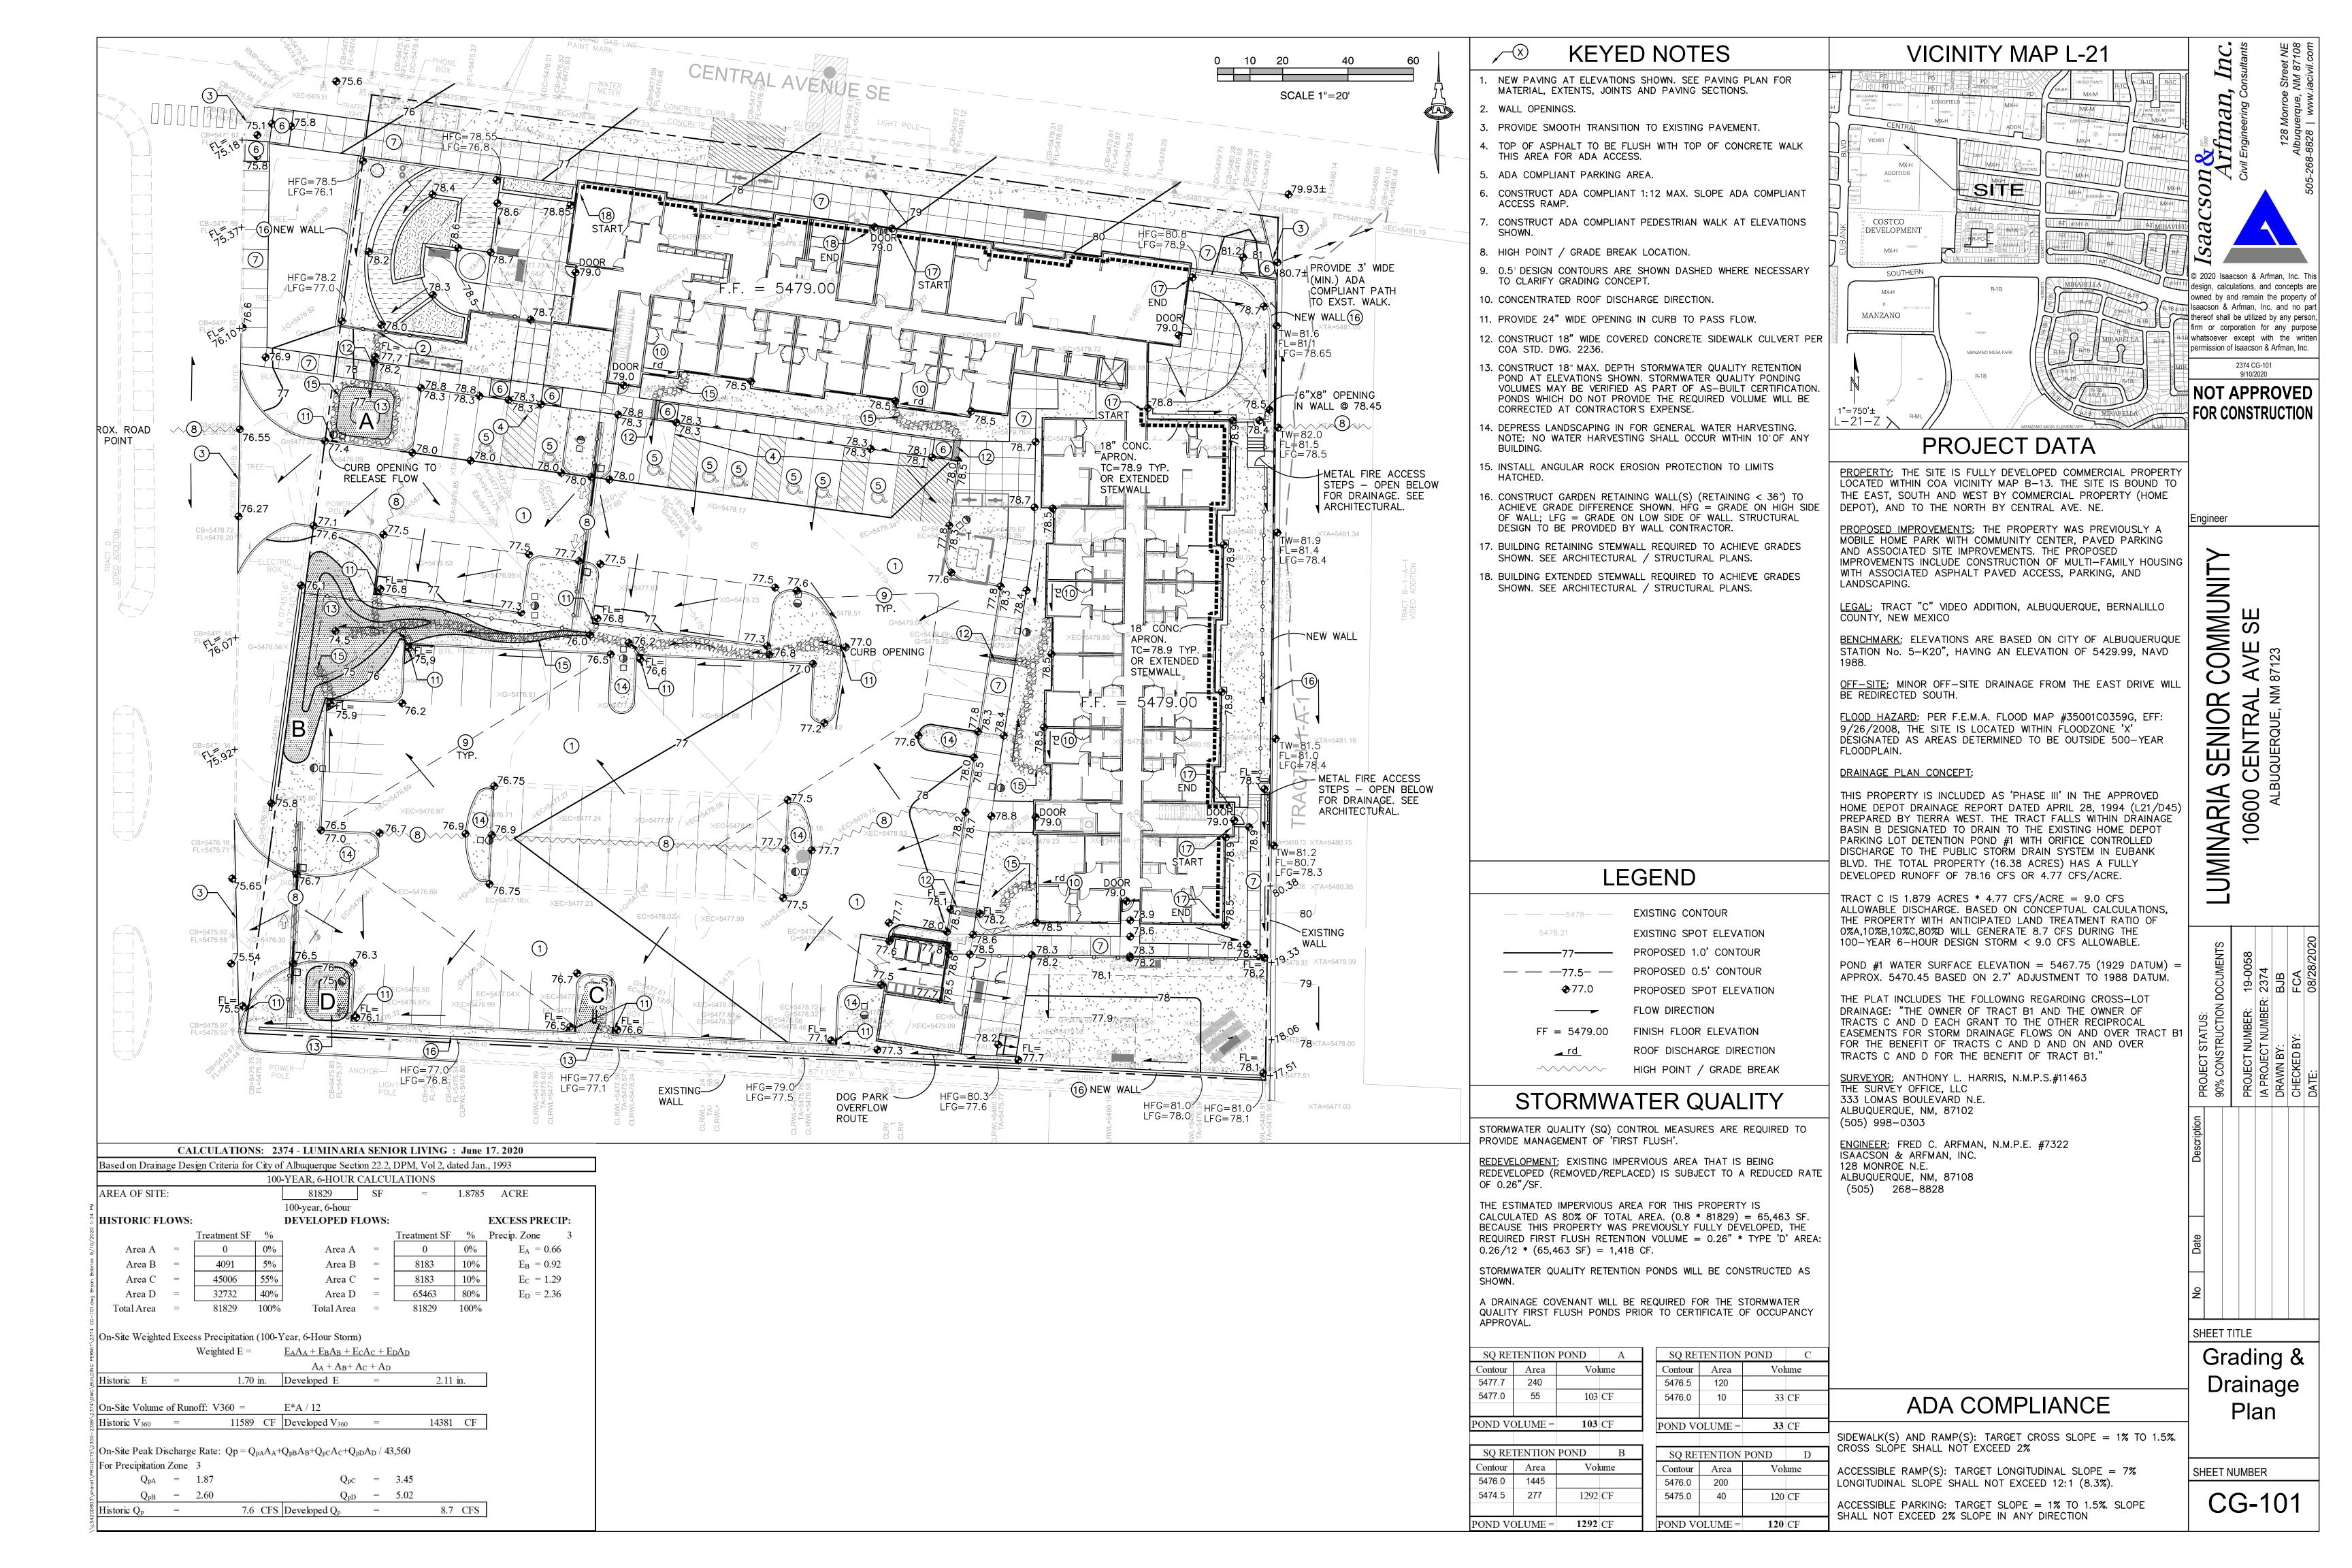


KEYED NOTES

MATER KEYED NOTES

- 1. REMOVE EXISTING CAP AND CONNECT NEW WATERLINE.
- 2. 6" 45° BEND. (LT=6')
- 3. 6" WATERLINE.
- 4. 6" GATE VALVE W/ BOX. PER ABCWUA STD DWG 2326 & 2329. (LT=46')
- 5. FIRE HYDRANT PER ABCWUA STD DWG 2340. PAINTED SAFETY ORANGE.
- 6. PIV (POST INDICATOR VALVE).
- 7. TONDUIT W/ PULL STRING FROM PIV TO FIRE ROOM.
- 8. WALL MOUNT FDC (FIRE DEPARTMENT CONNECTION).
- 9. REMOVE EXISTING 3" CAP AND CONNECT NEW 3" WATER SERVICE
- 10. 3" WATER SERVICE LINE.

SEWER KEYED NOTES

- 20. REMOVE 8" PLUG AND CONNECT NEW 6" SAS SERVICE LINE..
- 21. 8" SANITARY SEWER SERVICE AT 2% MIN. SLOPE

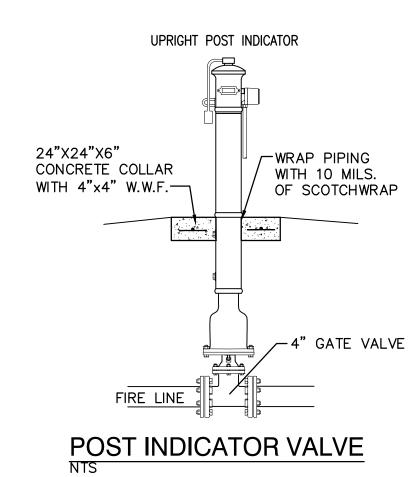

GENERAL NOTES

- 1. EXISTING UTILITY LINES ARE SHOWN IN AN APPROXIMATE MANNER ONLY AND MAY BE INCOMPLETE OR OBSOLETE. SUCH LINES MAY OR MAY NOT EXIST WHERE SHOWN OR NOT SHOWN. ALL UTILITIES SHOULD BE FIELD VERIFIED AND LOCATED BY THE CONTRACTOR PRIOR TO COMMENCEMENT OF ANY CONSTRUCTION. THE CONTRACTOR IS FULLY RESPONSIBLE FOR ANY AND ALL DAMAGE CAUSED BY ITS FAILURE TO LOCATE, IDENTIFY AND PRESERVE ANY AND ALL EXISTING UTILITIES, PIPELINES, AND UNDERGROUND UTILITY
- 2. CONTRACTOR SHALL NOT USE VIBRATORY COMPACTION EQUIPMENT OR HEAVY VEHICLES OVER EXISTING UTILITIES.
- 3. SITE STORM DRAIN, ELECTRIC LINES & TRANSFORMERS AND GAS LINES ARE SHOWN FOR GENERAL INFORMATION ONLY TO PROVIDE AN OVERVIEW OF SITE UTILITIES AND POTENTIAL CONFLICTS. SEE MECHANICAL PLANS FOR GAS LINE SIZING. SEE CG-101 FOR STORM DRAIN DESIGN.
- 4. ALL ABOVE GROUND UTILITY EQUIPMENT AND FITTINGS SHALL BE PAINTED IN COLORS TO MATCH BUILDING COLORS.

RESTRAINED JOINT CRITERIA

FOR WATERLINE FITTINGS

- 1. ALL MECHANICAL JOINTS SHALL BE RESTRAINED AT THE FITTINGS PER KEYED NOTES THIS SHEET.
- 2. THE CONTRACTOR SHALL PROVIDE A MINIMUM PIPE LENGTH OF 20 LF FROM ALL MECHANICAL JOINTS. ALL PIPE JOINTS WITHIN 20 LF OF A MECHANICAL JOINT SHALL BE RESTRAINED AT THE CONTRACTOR'S EXPENSE.
- 3. THE CONTRACTOR SHALL RESTRAIN ALL PIPE JOINTS IN THE SPECIFIED DISTANCE LISTED IN THE KEYED NOTES.
- 4. THE CONTRACTOR SHALL RESTRAIN ALL FIRE HYDRANT JOINTS FROM THE TEE ON THE MAIN TO THE FIRE HYDRANT FLANGE.

DEPTH OF BURY: 3.0 FT. MINIMUM FACTOR OF SAFETY: 1.50

MATERIAL: PVC SOIL TYPE:

GM/SM - SILTY GRAVELS AND SILTY SANDS, GRAVEL-

SAND-SILT MIXTURES. TEST PRESSURE: 150 PSI

TRENCH TYPE 4: PIPE BEDDED IN SAND, GRAVEL, OR CRUSHED STONE TO DEPTH

> OF 1/8 PIPE DIAMETER, 4 INCH MINIMUM; BACKFILL COMPACTED


TO TOP OF PIPE.

DIFFERENT CRITERIA, E.G., GREATER DEPTH OF BURY, ETC., WILL REQUIRE DIFFERENT RESTRAINED LENGTHS. THESE MUST BE CALCULATED BY A QUALIFIED PROFESSIONAL ENGINEER AND APPROVED BY ABCWUA.

LEGEND

w_	— — EXISTING WATERLINE			
\triangleleft	EXISTING FIRE HYDANT			
\triangleright	EXISTING WATER VALVE			
	— — EXISTING SEWER LINE			
 	EXISTING SEWER MANHOLE			
	NEW FIRE LINE			
•	NEW FIRE HYDANT			
M	NEW WATER VALVE			
\	NEW FDC			
(T)	NEW PIV			

NEW SEWER LINE

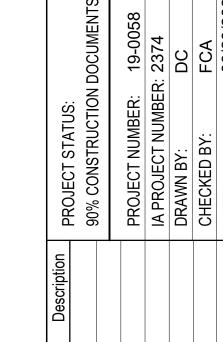

Isaacson & Figure 18 Arfman, Civil Engineering Con

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2374 CU-101 9/10/2020

Engineer

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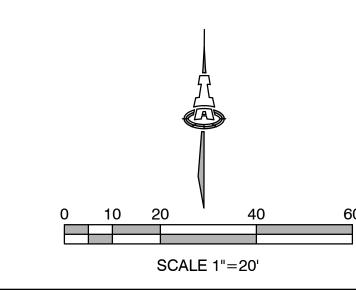
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LUMINARIA 10600

SHEET TITLE **Utility Plan**

SHEET NUMBER


CU-101









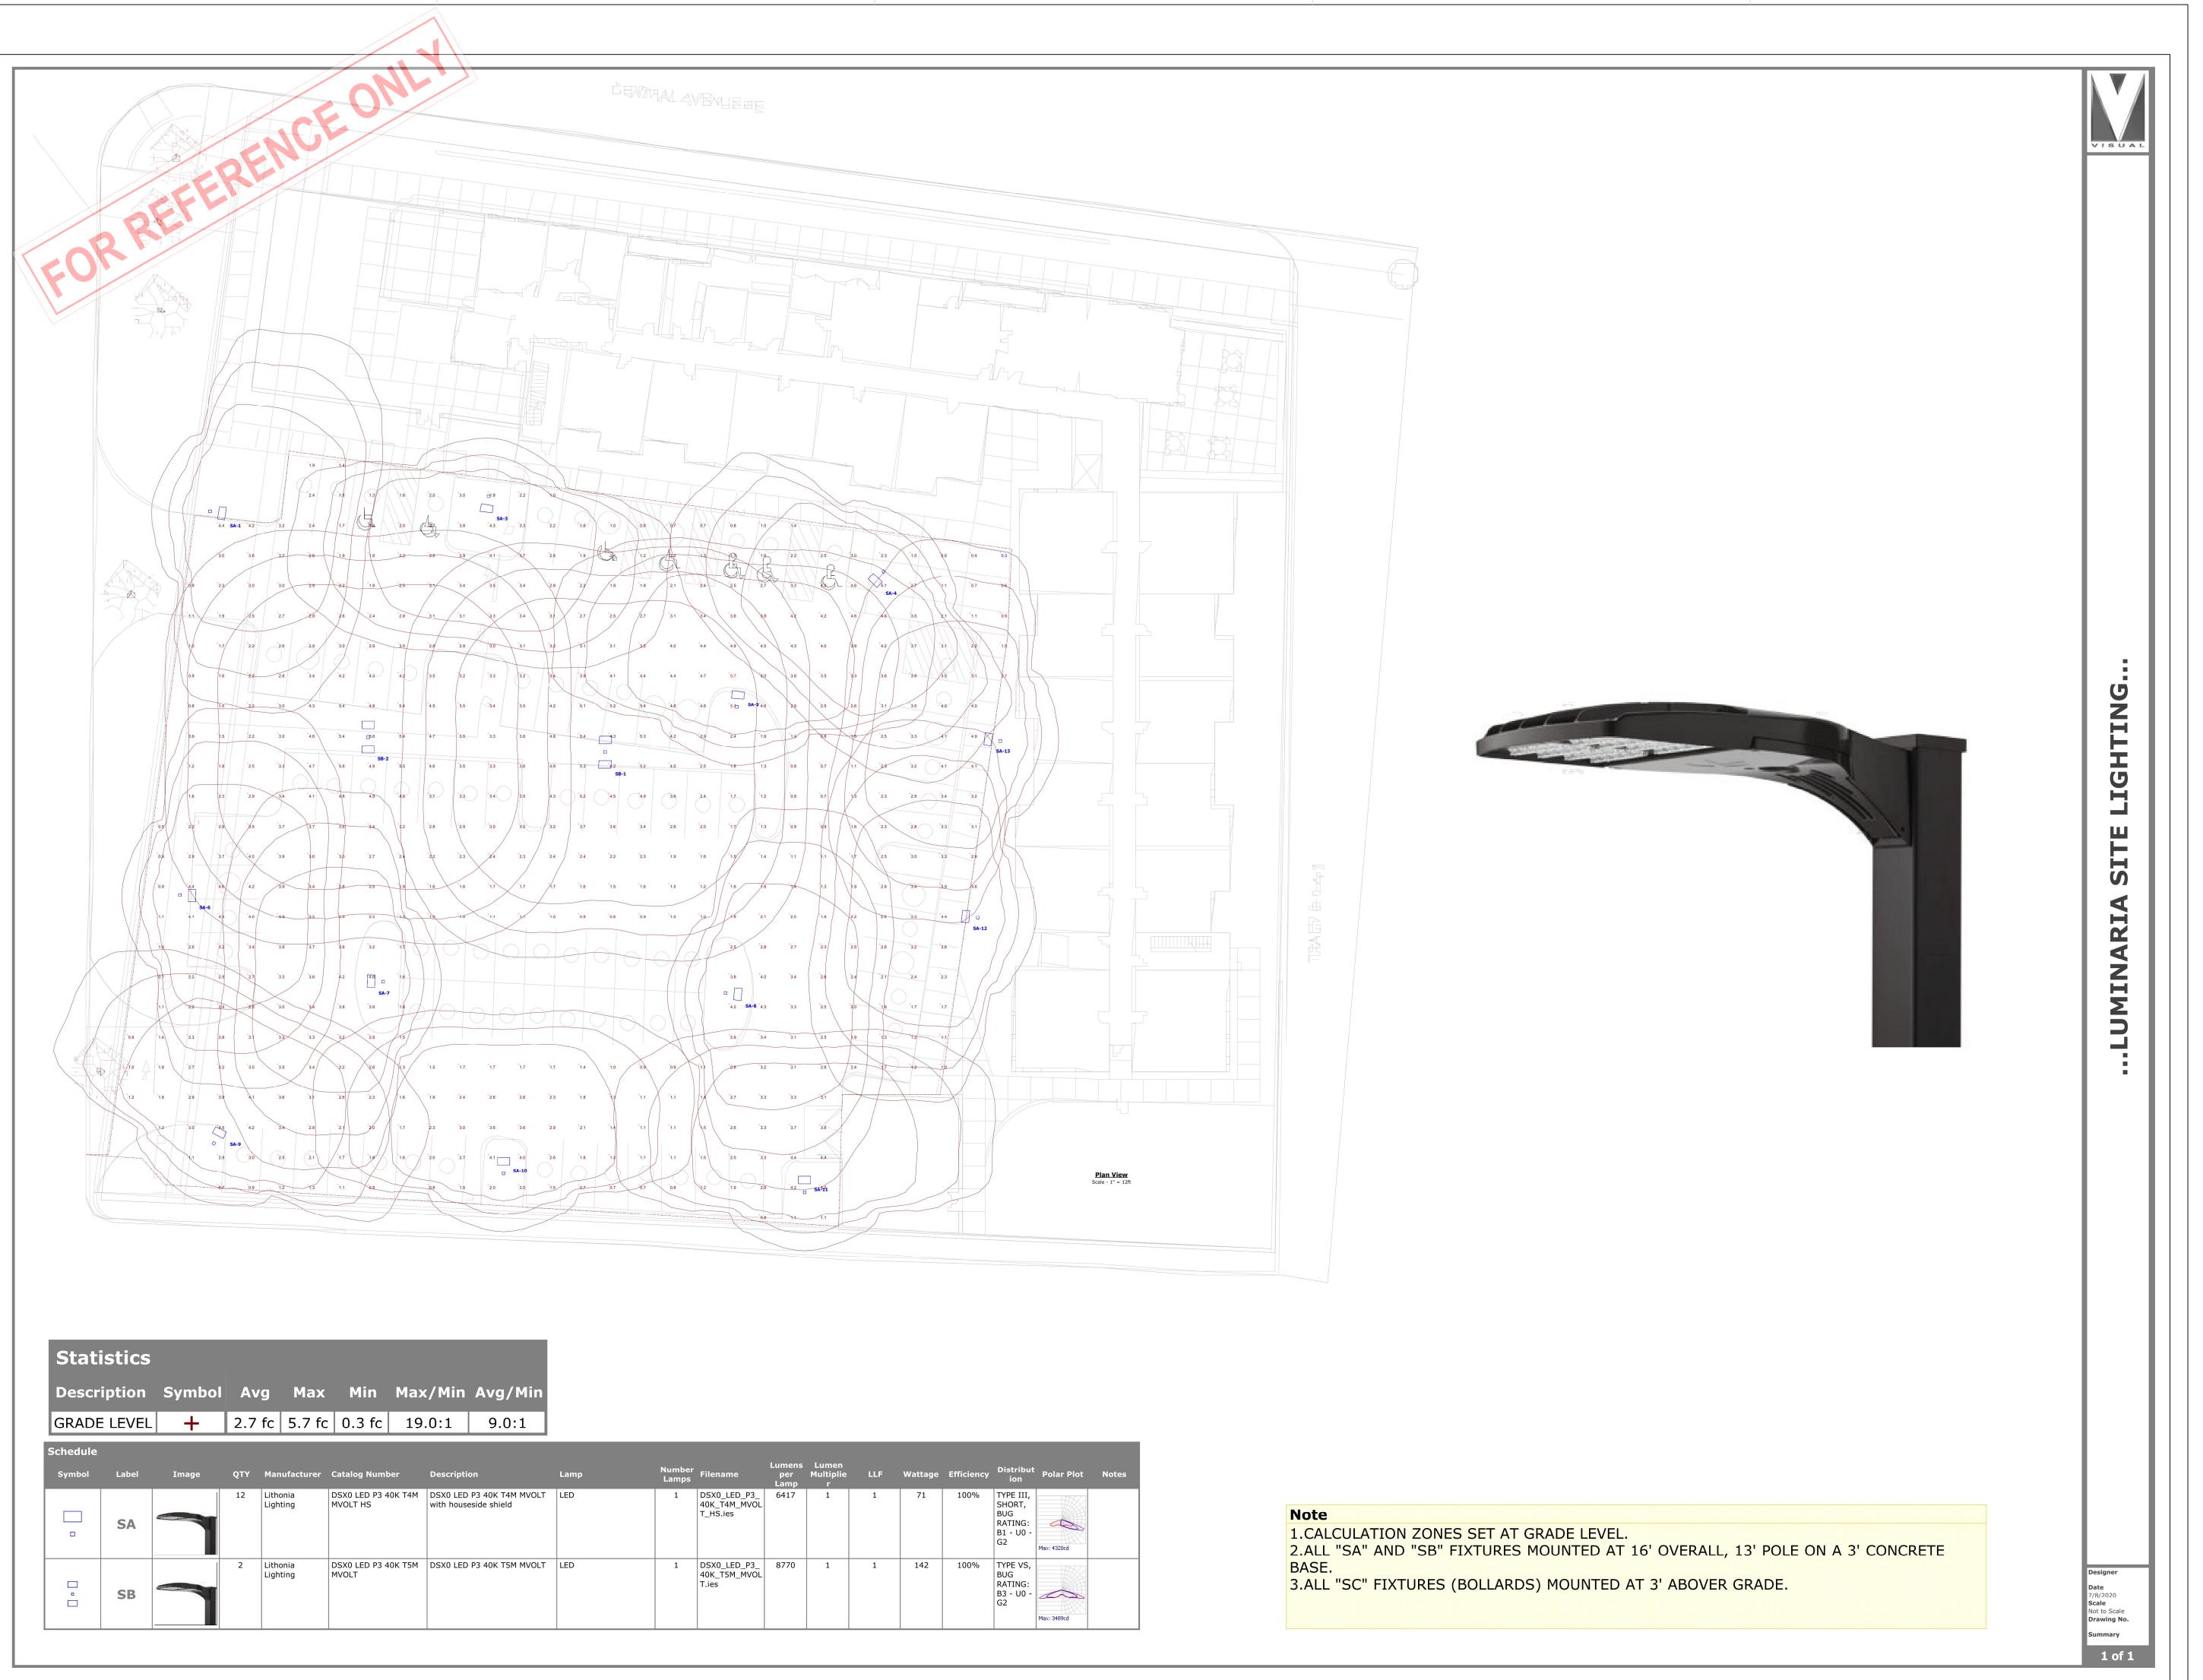

DEKKER PERICH SABATINI

ARCHITECTURE DESIGN INSPIRATION

N DOLUTEOT

ENGINEER

PRO IFO

UMINARIA SENIOR COMMUNI
10600 CENTRAL AVE SE
ALBUQUERQUE, NM 87123


APPLICATION TO DESIGN REVIEW BOARD (DRB)

DRAWN BY	AG, JF
REVIEWED BY	RAW, JM
DATE	08/28/2020
PROJECT NO.	19-0058
DRAWING NAME	


SITE LIGHTING FOR REFERENCE

SHEET NO.

DP6.

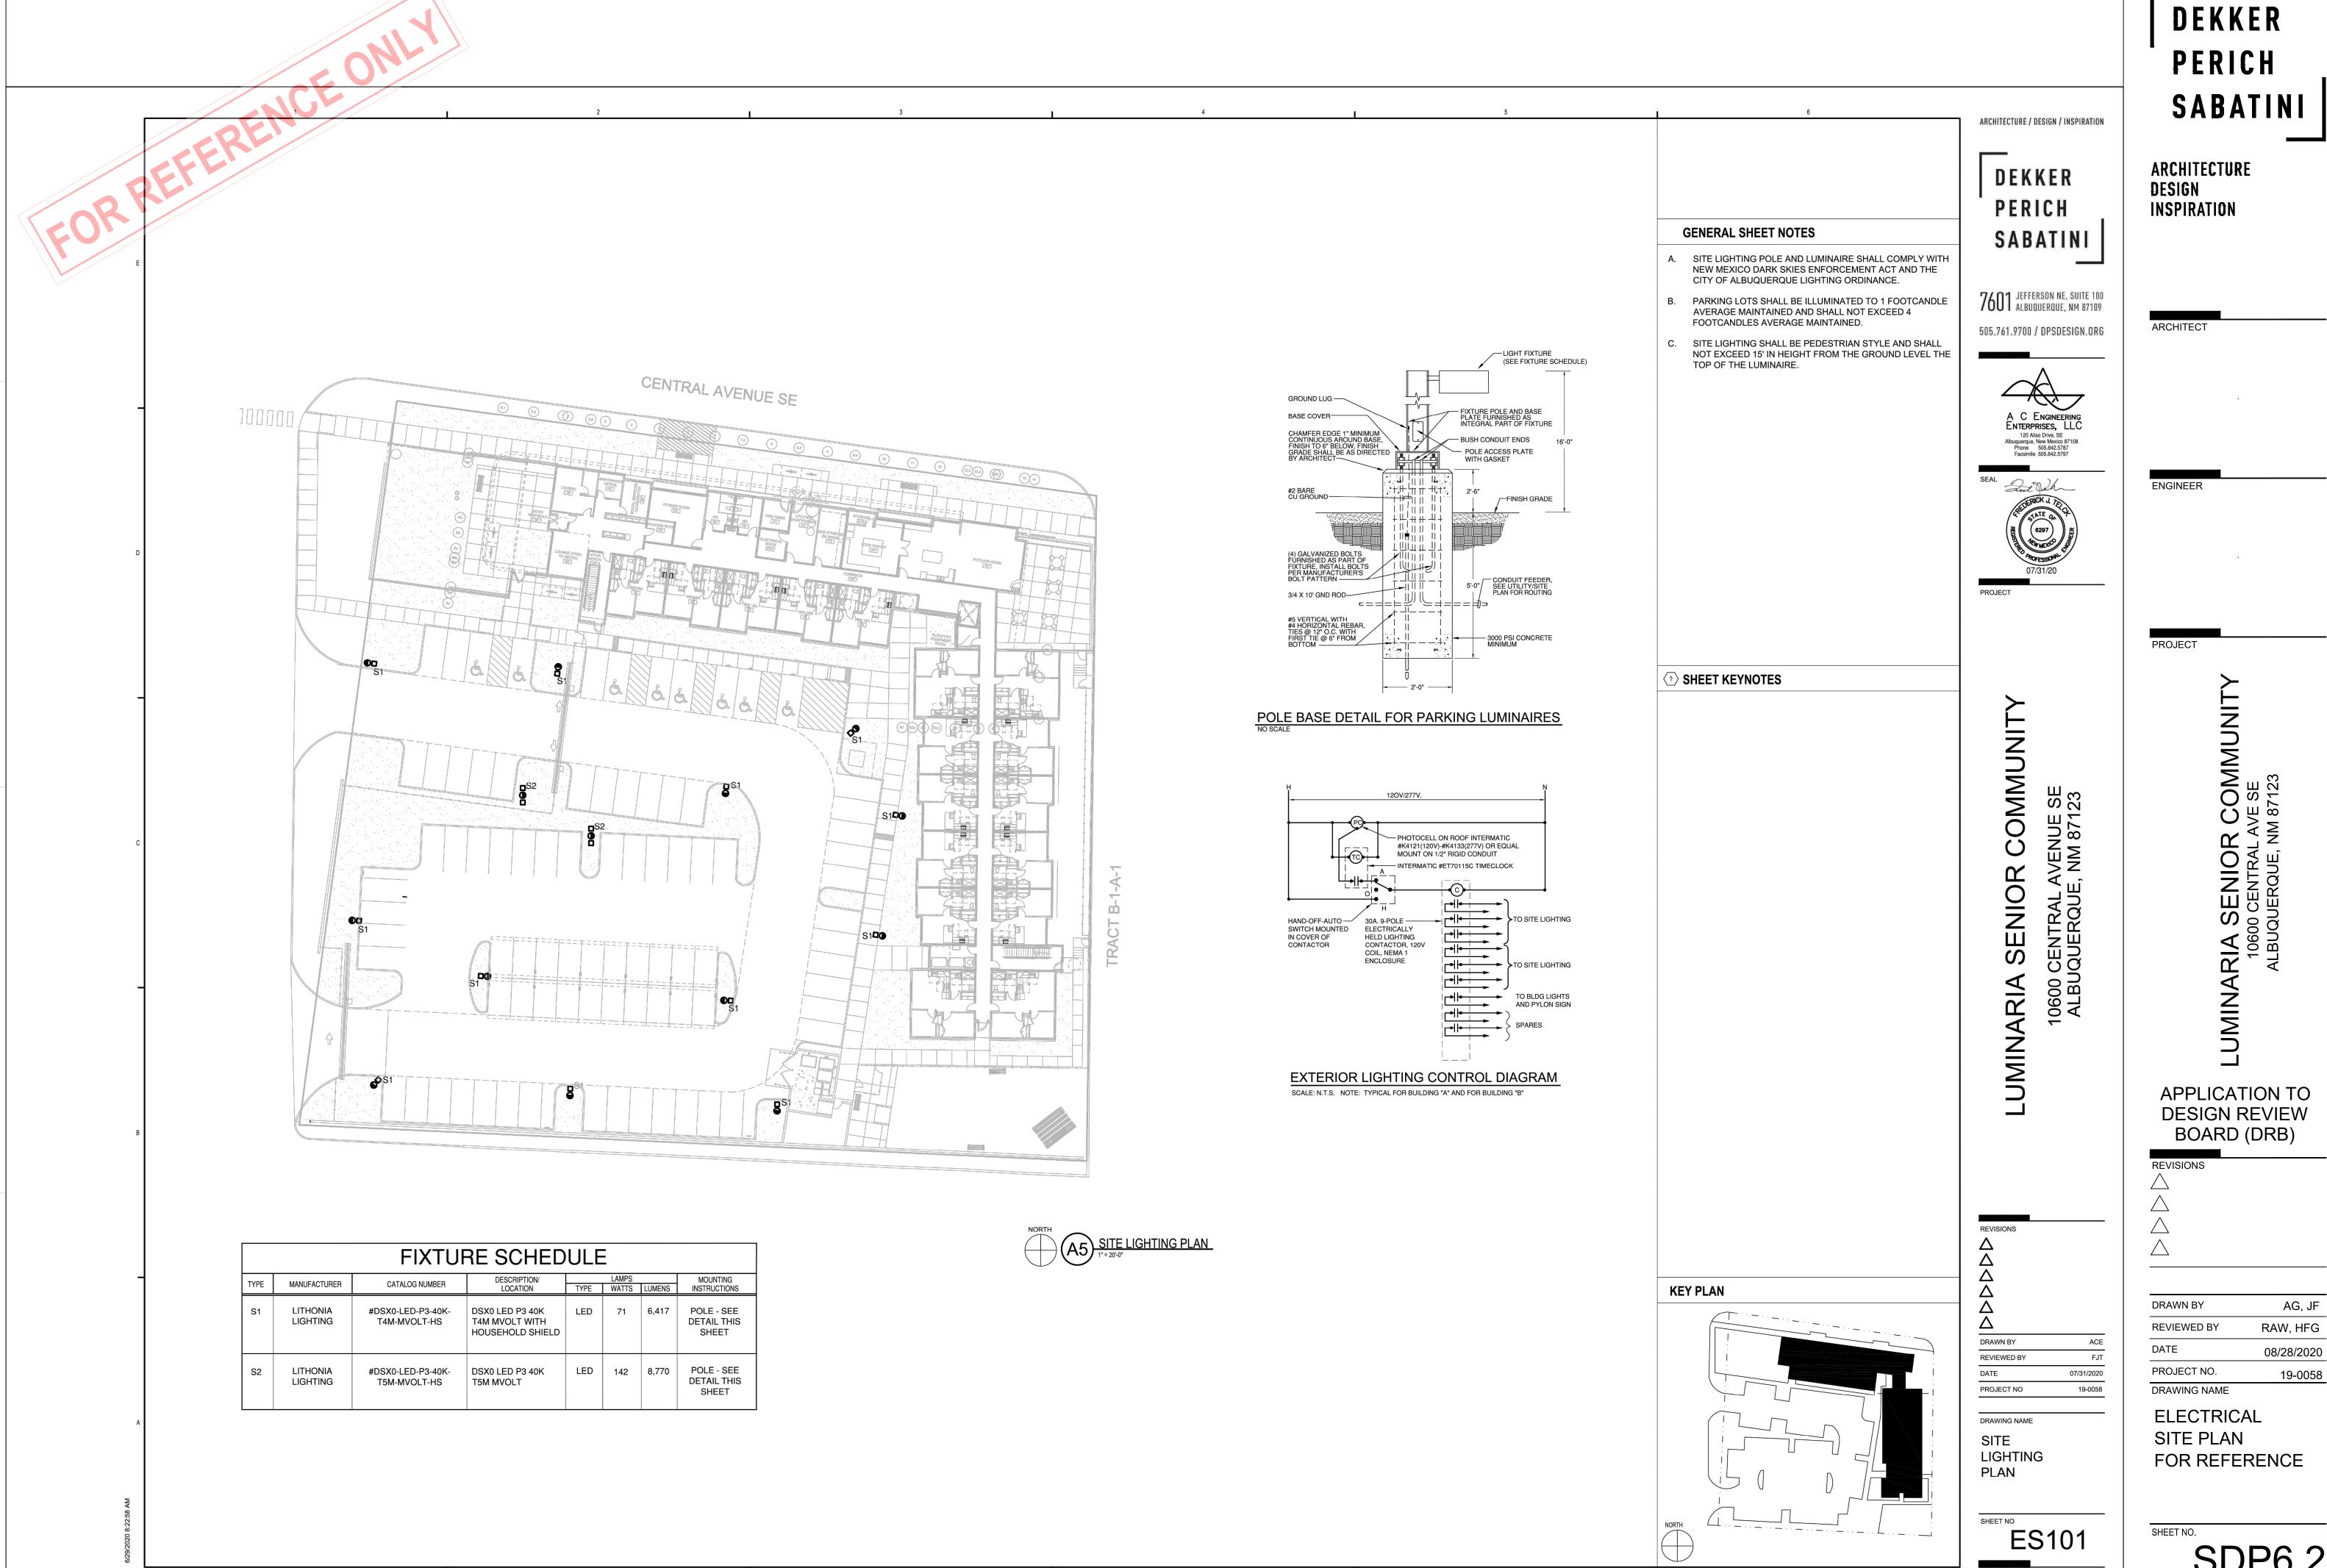

SDP6.2

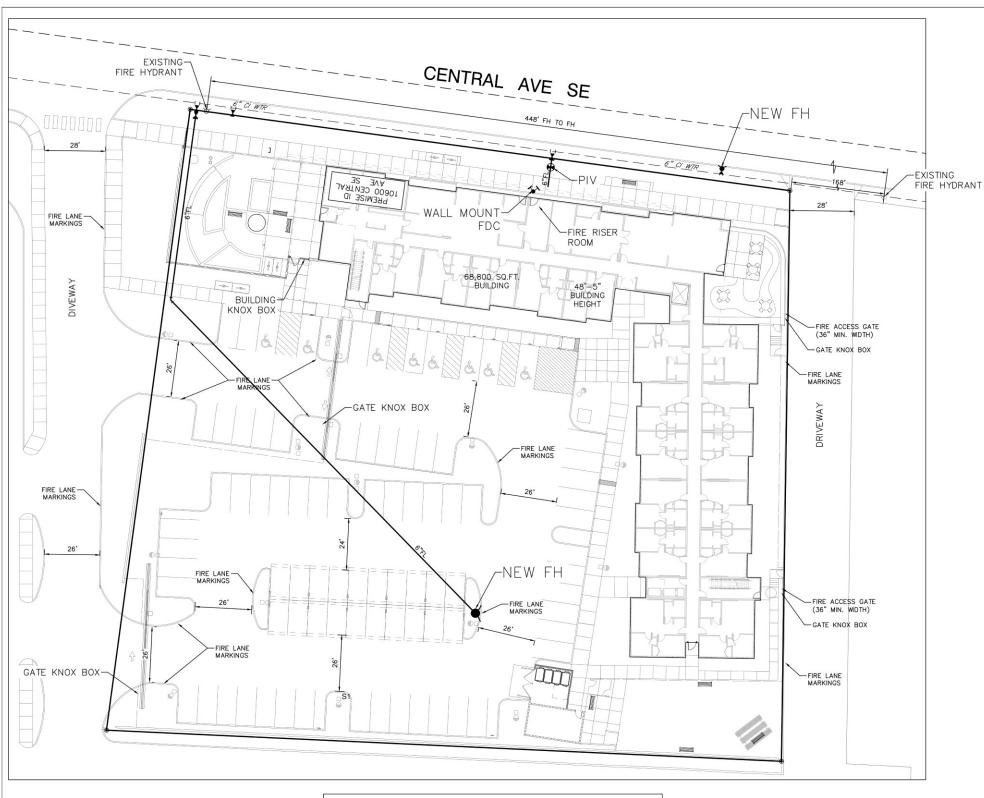

ROOF ACCESS TO SOUTH WING FROM

INTERNAL FIRE LANE AND FROM CENTRAL AVE.

BELAMANS

CONTRACTED

SUZ EG-C

SUZ


10,600 CENTRAL AVE, SE ALBUQUERQUE, NM 87123

68,800 SQ. FT BUILDING
TYPE VA CONSTRUCTION
SPRINKLED
48'-5" BUILDING HEIGHT
OCCUPANCY GROUP-RES. R-2

2 EXISTING FIRE HYDRANT NEAR SITE

ALL ACCESS ROADS AND FIRE LANES HAVE GRADES LESS THAN 10% AND A LOAD CAPACITY OF 75,000 POUNDS.

ALL ACCESS ROADS AND FIRE LANES WILL ACCOMMODATE A 28' MINIMUM TRUCK TURNING RADIUS

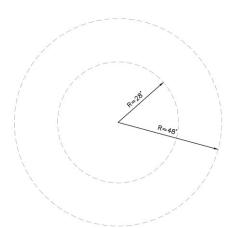

FIRE 1 PERMIT
ALBUQUERQUE FIRE MARSHAL'S
OFFICE PLANS CHECK DIVISION
PERMIT NUMBER: 20-0903093, revised
APPROVED BY:
APPROVED BY:
APPROVED DATE: 08/24/2020

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SQFT: 68800 CONSTRUCTION TYPE: V-A
GPM: 2375 NUMBER OF HYDRANTS: 3
THESE CONSTRUCTION DOCUMENTS WERE REVIEWED AND APPROVED BY
THE ALBUQUERQUE FIRE MARSHAL® OFFICE IN ACCORDANCE WITH CITY
ORDINANCE, THE INTERNATIONAL FIRE CODE, AND NPFA STANDANDS.
THIS PERMIT IS VALID FOR 180 DAYS. FIRSAL INSPECTION IS REQUIRED.

0 10 20 40 60 SCALE 1"=20'

FIRE APPARATUS TURNING RADIUS
1"=20'

ISaacson & Arfman, Inc.
Arfman, Inc.
Civil Engineering Consultants
128 Monroe Street NE
Albuqueque, NM 87108
505-265-8898 I www.isardionands

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LUMINARIA SENIOR COMMUNITY 10600 CENTRAL AVE SE ALBUQUERQUE, NM 87123

| No | Dale | Description | PROJECT STATUS; | 50% DESIGN DEVELOPMENT | 50% DESIGN DEVELOPMENT | PROJECT NUMBER: 19-0058 | IA PROJECT NUMBER: 2374 | DRAWN BY: BJB | CHECKED BY: FCA | DATE: 07/10/2020 |

LOCATION AND ACCESS PLAN

FIRE HYDRANT

SHEET NUMBER

FIRE-1